

Q ST. COMMONS										2018 04 20				
UNITS					LEVELS									
NAME	BEDS	BEDROOM	BATHROOMS	NET SF	LVL 01	LVL 02	LVL 03	LVL 04	LVL 05	LVL 06	TOTAL UNITS	% UNITS	TOTAL BEDS	TOTAL NSF
ST1	1	0	1	452	0	1	1	1	1	1	5	20	5	2260
ST1B	1	0	1	452	0	1	1	1	1	1	5	20	5	2260
ST2	1	0	1	345	0	2	2	2	2	2	10	16.00%	10	3450
B1	2	2	2	869	0	1	1	1	1	1	5	15	10	4345
B2	2	2	2	985	0	1	1	1	1	1	5	12.00%	10	4925
В3	2	2	2	885	0	1	1	1	1	1	5	12.00%	10	4425
D1	4	4	4	1223	0	8	10	10	10	10	48	76	192	58704
D1B	4	4	4	1254	0	2	3	3	3	3	14		56	17556
D2	4	4	4	1480	0	1	1	1	1	1	5	60.80%	20	7400
D3	4	4	4	1582	0	1	1	1	1	1	5	60.80%	20	7910
D4	4	4	4	1519	0	0	1	1	1	1	4		16	6076
E1	5	4	4	1519	0	1	1	1	1	1	5	14	25	7595
E3	5	4	4	1650	0	0	1	1	1	1	4	11 20%	20	6600
E4	5	4	4	1498	0	1	1	1	1	1	5	11.20%	25	7490
					0	14	19	19	19	19	125	100.00%	424	140996

PARKING REQUIREMENTS

CITY OF SACRAMENTO PARKING REQUIREMENTS (.5 SPOTS/UNIT)

125 UNITS*.5 = 63 SPACES REQUIRED

103 SPACES PROVIDED

PARKING							
TYPE	COUNT	SF/SPOT	TOTAL SF				
REGULAR	47	153	7191				
COMPACT(8.5'X15')	11	120	1320				
COMPACT(8'X15')	28	127	3556				
TANDEM	12	306	3672				
ACCESSIBLE VAN	1	198	198				
ACCESSIBLE	4	144	576				
TOTAL	103		16513				

TOTAL SF OF PARKING STALLS AND DRIVE

28,032 SF

BIKE PARKING REQUIREMENTS

CITY OF SACRAMENTO BIKE PARKING REQUIREMENTS

SHORT TERM PARKING (1 SPACE/ 10 UNITS)

SHORT TERM BIKE PARKING REQUIRED - 13 SPACES (125 UNITS * .1 SPACE/UNIT)

14 SPACES PROVIDED

LONG TERM BIKE PARKING REQUIRED - 63 SPACES (125 UNITS*.5 SPACE/UNIT)

80 SPACES PROVIDED

COMMON AMENITY SPACES

RETAIL	
1636	

CE
1531
1290
1245
956
2012
1700
8734

N SF
456
1015
187
422
520
2600

PROJECT SUMMARY

Description:

Occupancy Group:

125 apartment units in 5 stories over 1 level of parking separated by podium

Address:

6779 Q. Street Sacramento, CA 95819

City of Sacramento Community: Sacramento Jurisdiction: City of Sacramento

Assessors Parcel Number: #015-0010-043-0000

NFPA 13 Sprinkler:

Level 1: Type 1A Level 2-6: Type 3A **Construction Type:**

Level 1: S-2(Parking), B (Leasing Center), A-3 (Amenity), A-2/B/M (Retail) Level 2-6: R-2 (Residential Apartment Units)

Project Index Sheet Number Sheet Name Cover Sheet A1.00 **Project Information Project Location** A1.01 Project Site Photographs A1.02 Project Site Photographs A1.03 D1.00 Site Demo Site Paving Plan Site Grading Plan Site Utility Plan Preliminary Plan Line Landscape Plan Site Plan A3.00 Bldg Lvl 01 Bldg Lvl 02 A3.01 Bldg Lvl 03 A3.02 A3.03 Bldg Lvl 04 A3.04 Bldg Lvl 05 Bldg Lvl 06 A3.05 Bldg Lvl Roof A3.06 A4.00 **Exterior Elevations** A4.01 **Bldg Section** Renderings A9.00 A9.01 Renderings A9.02 Renderings Materials



VICINITY MAP





AERIAL SITE MAP



























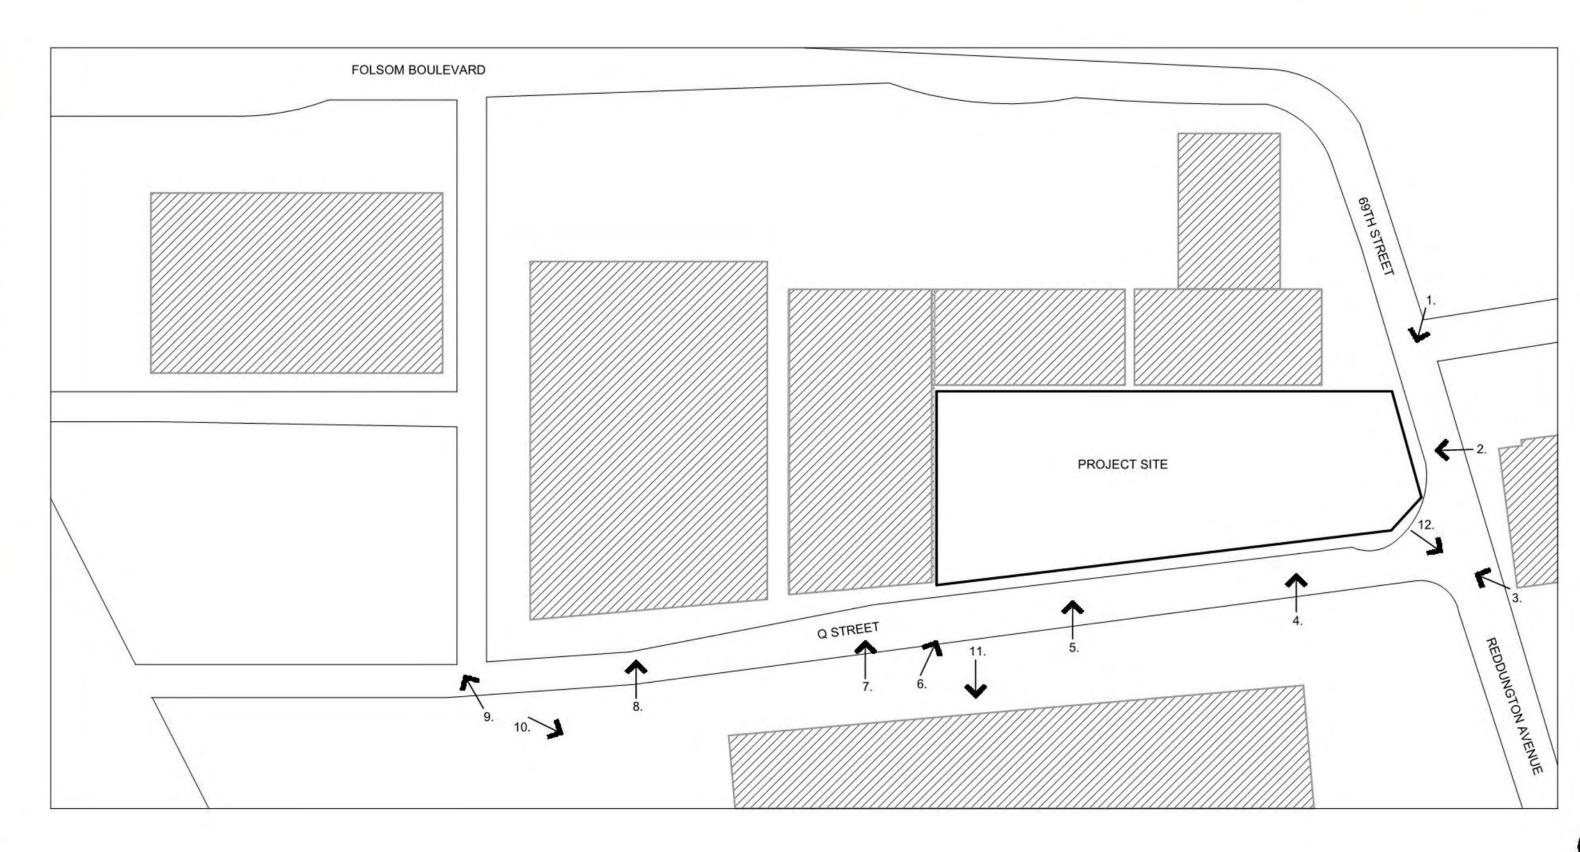




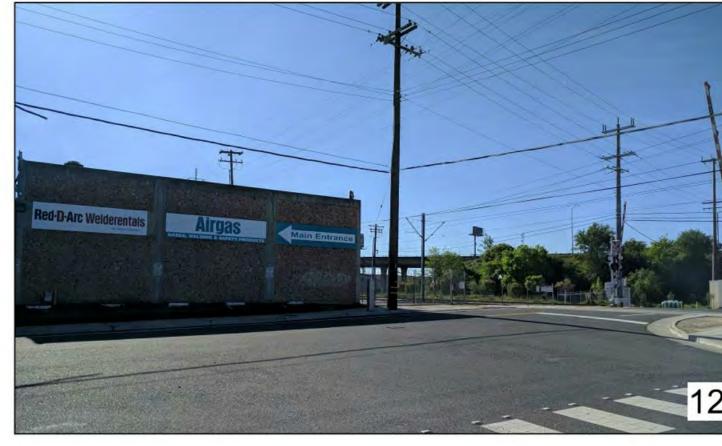








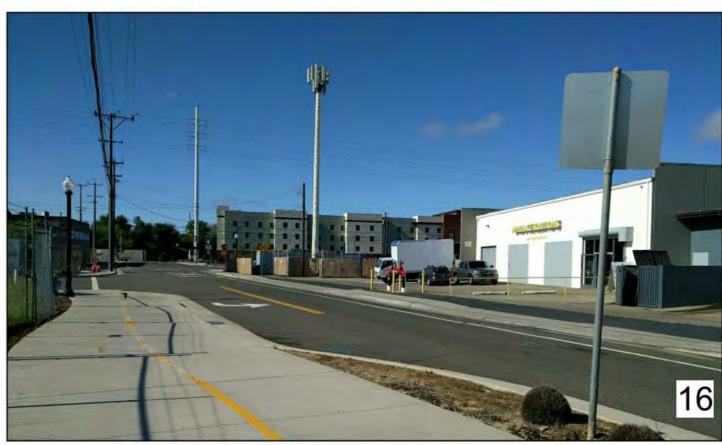









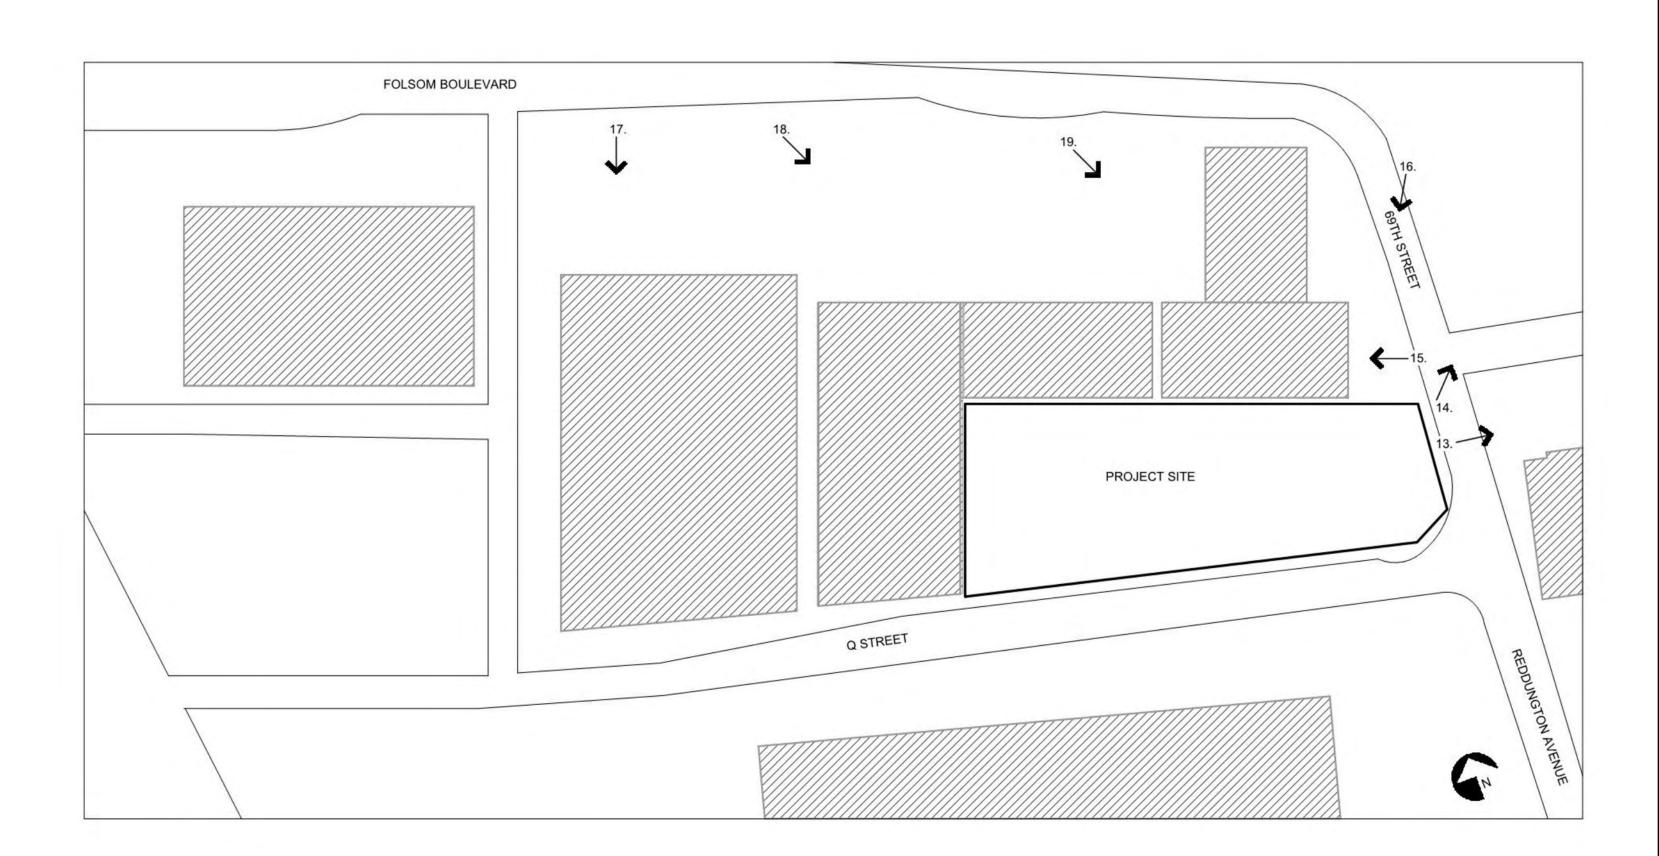

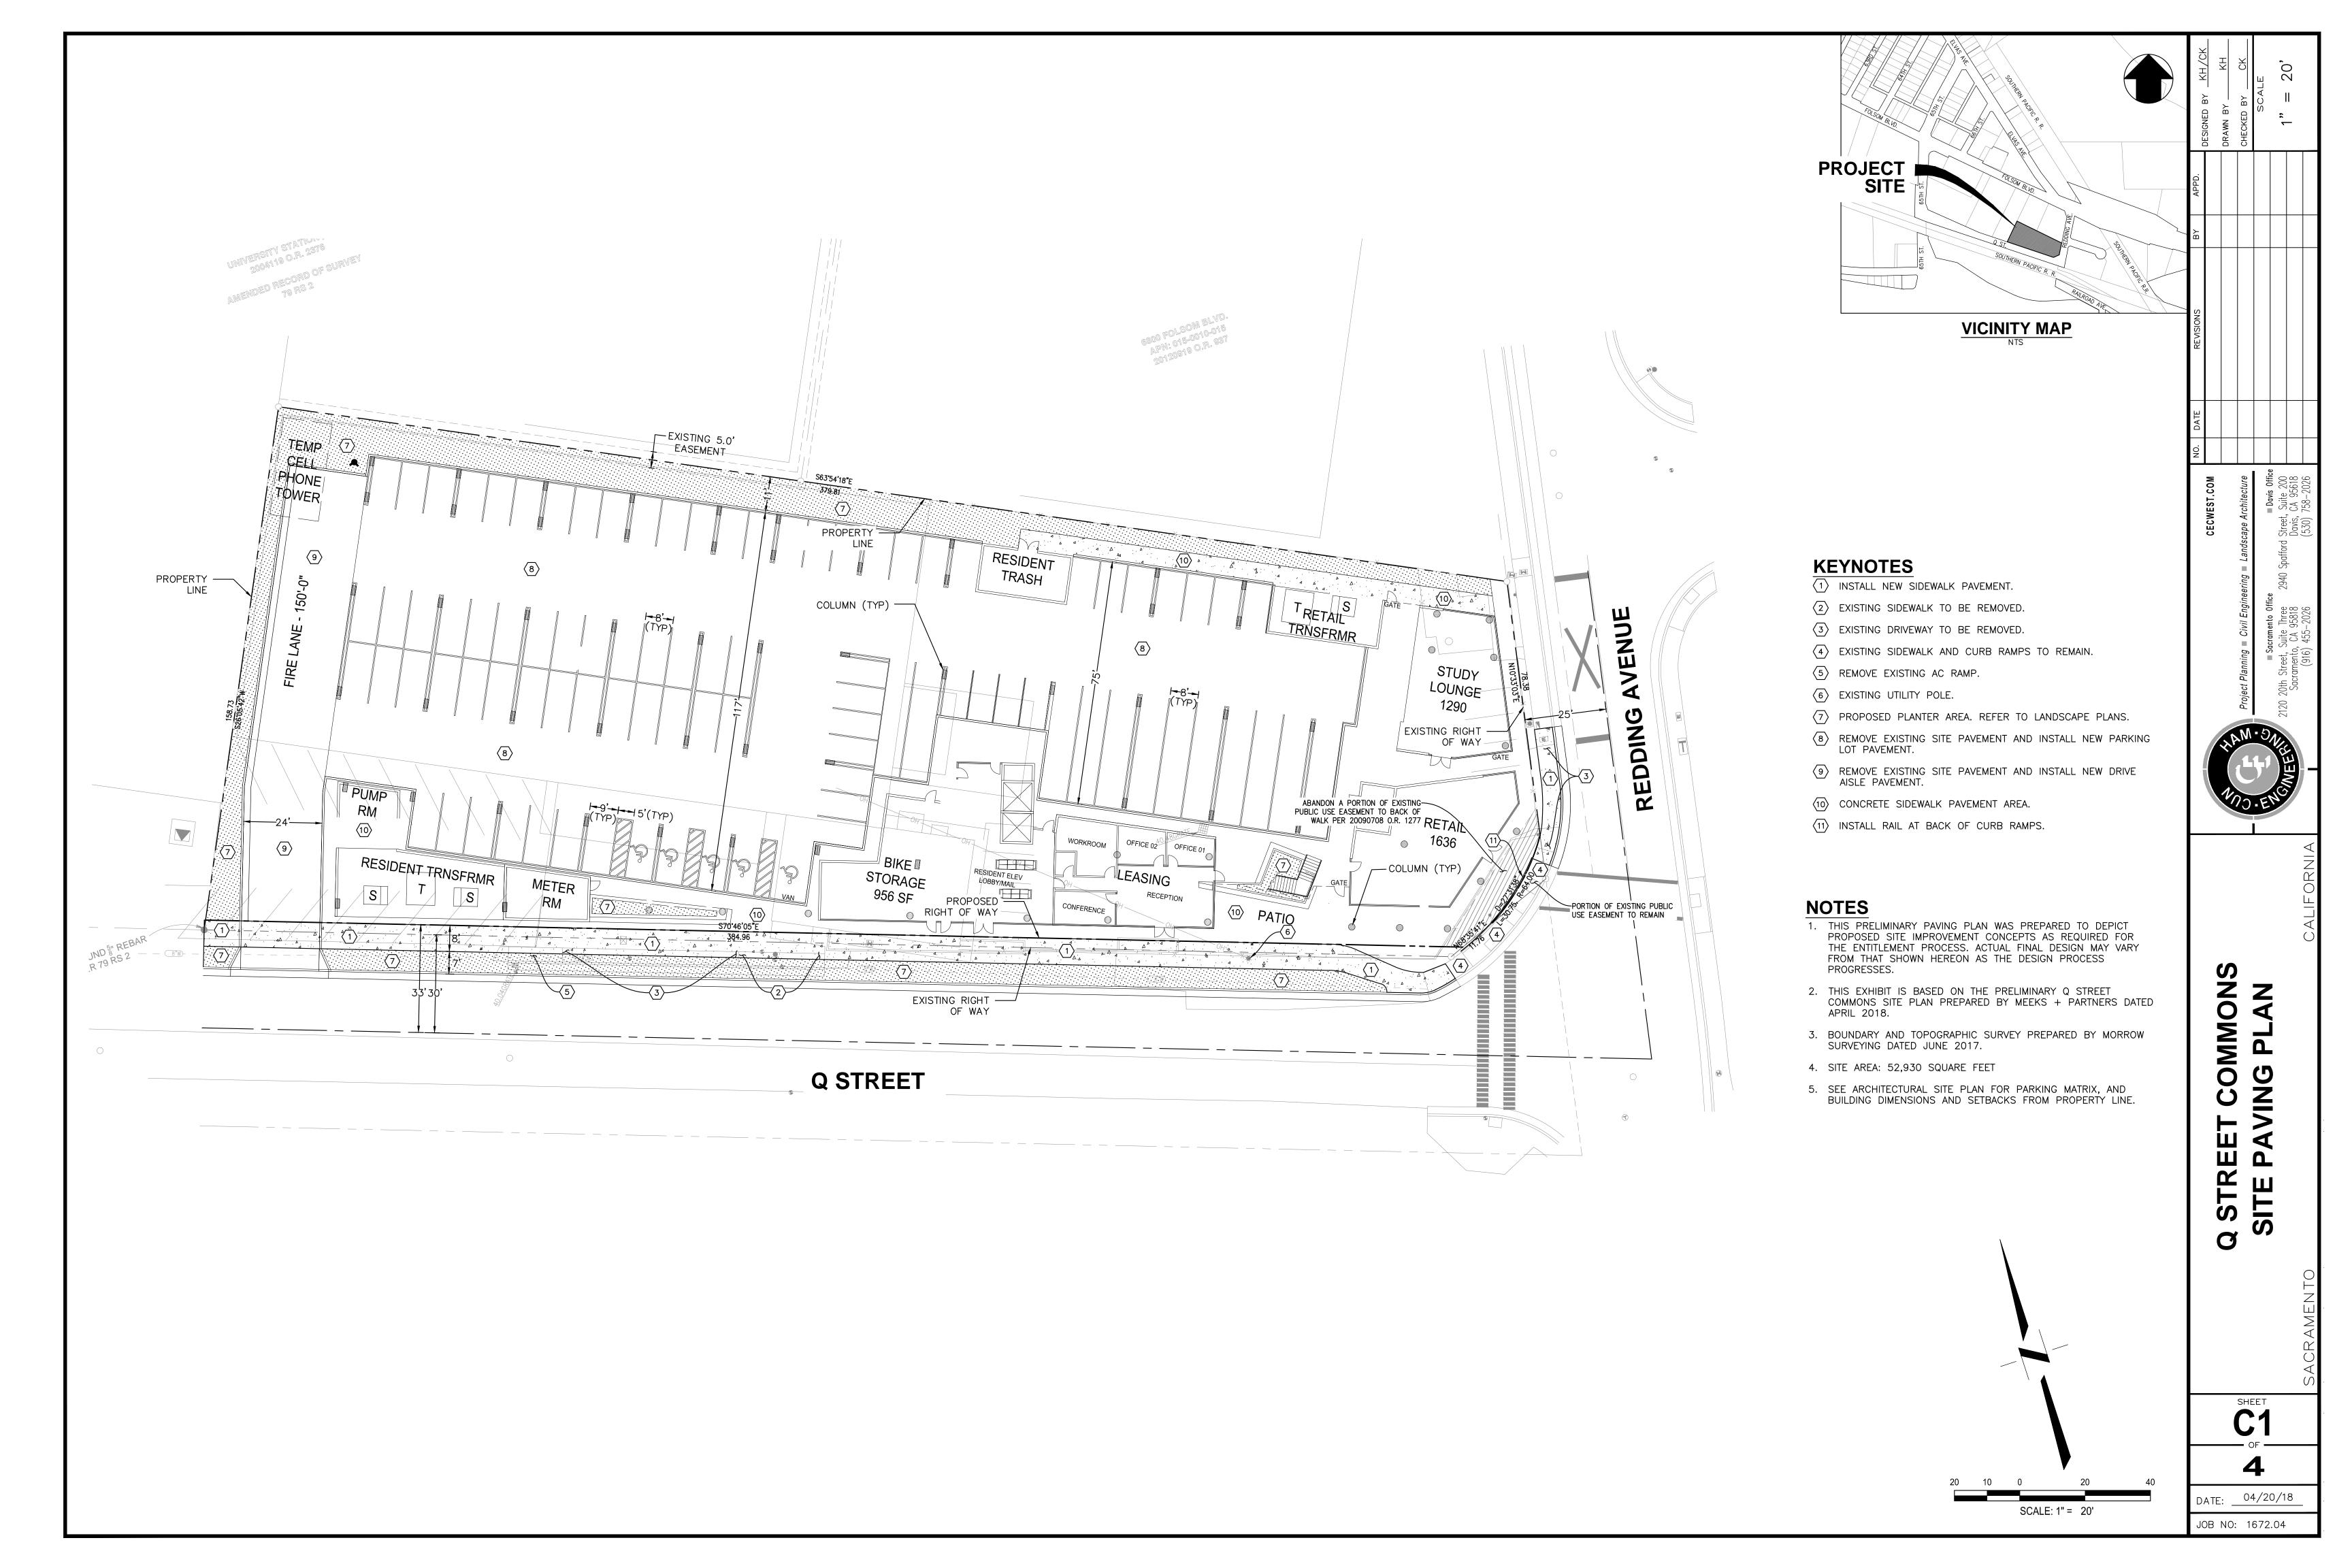

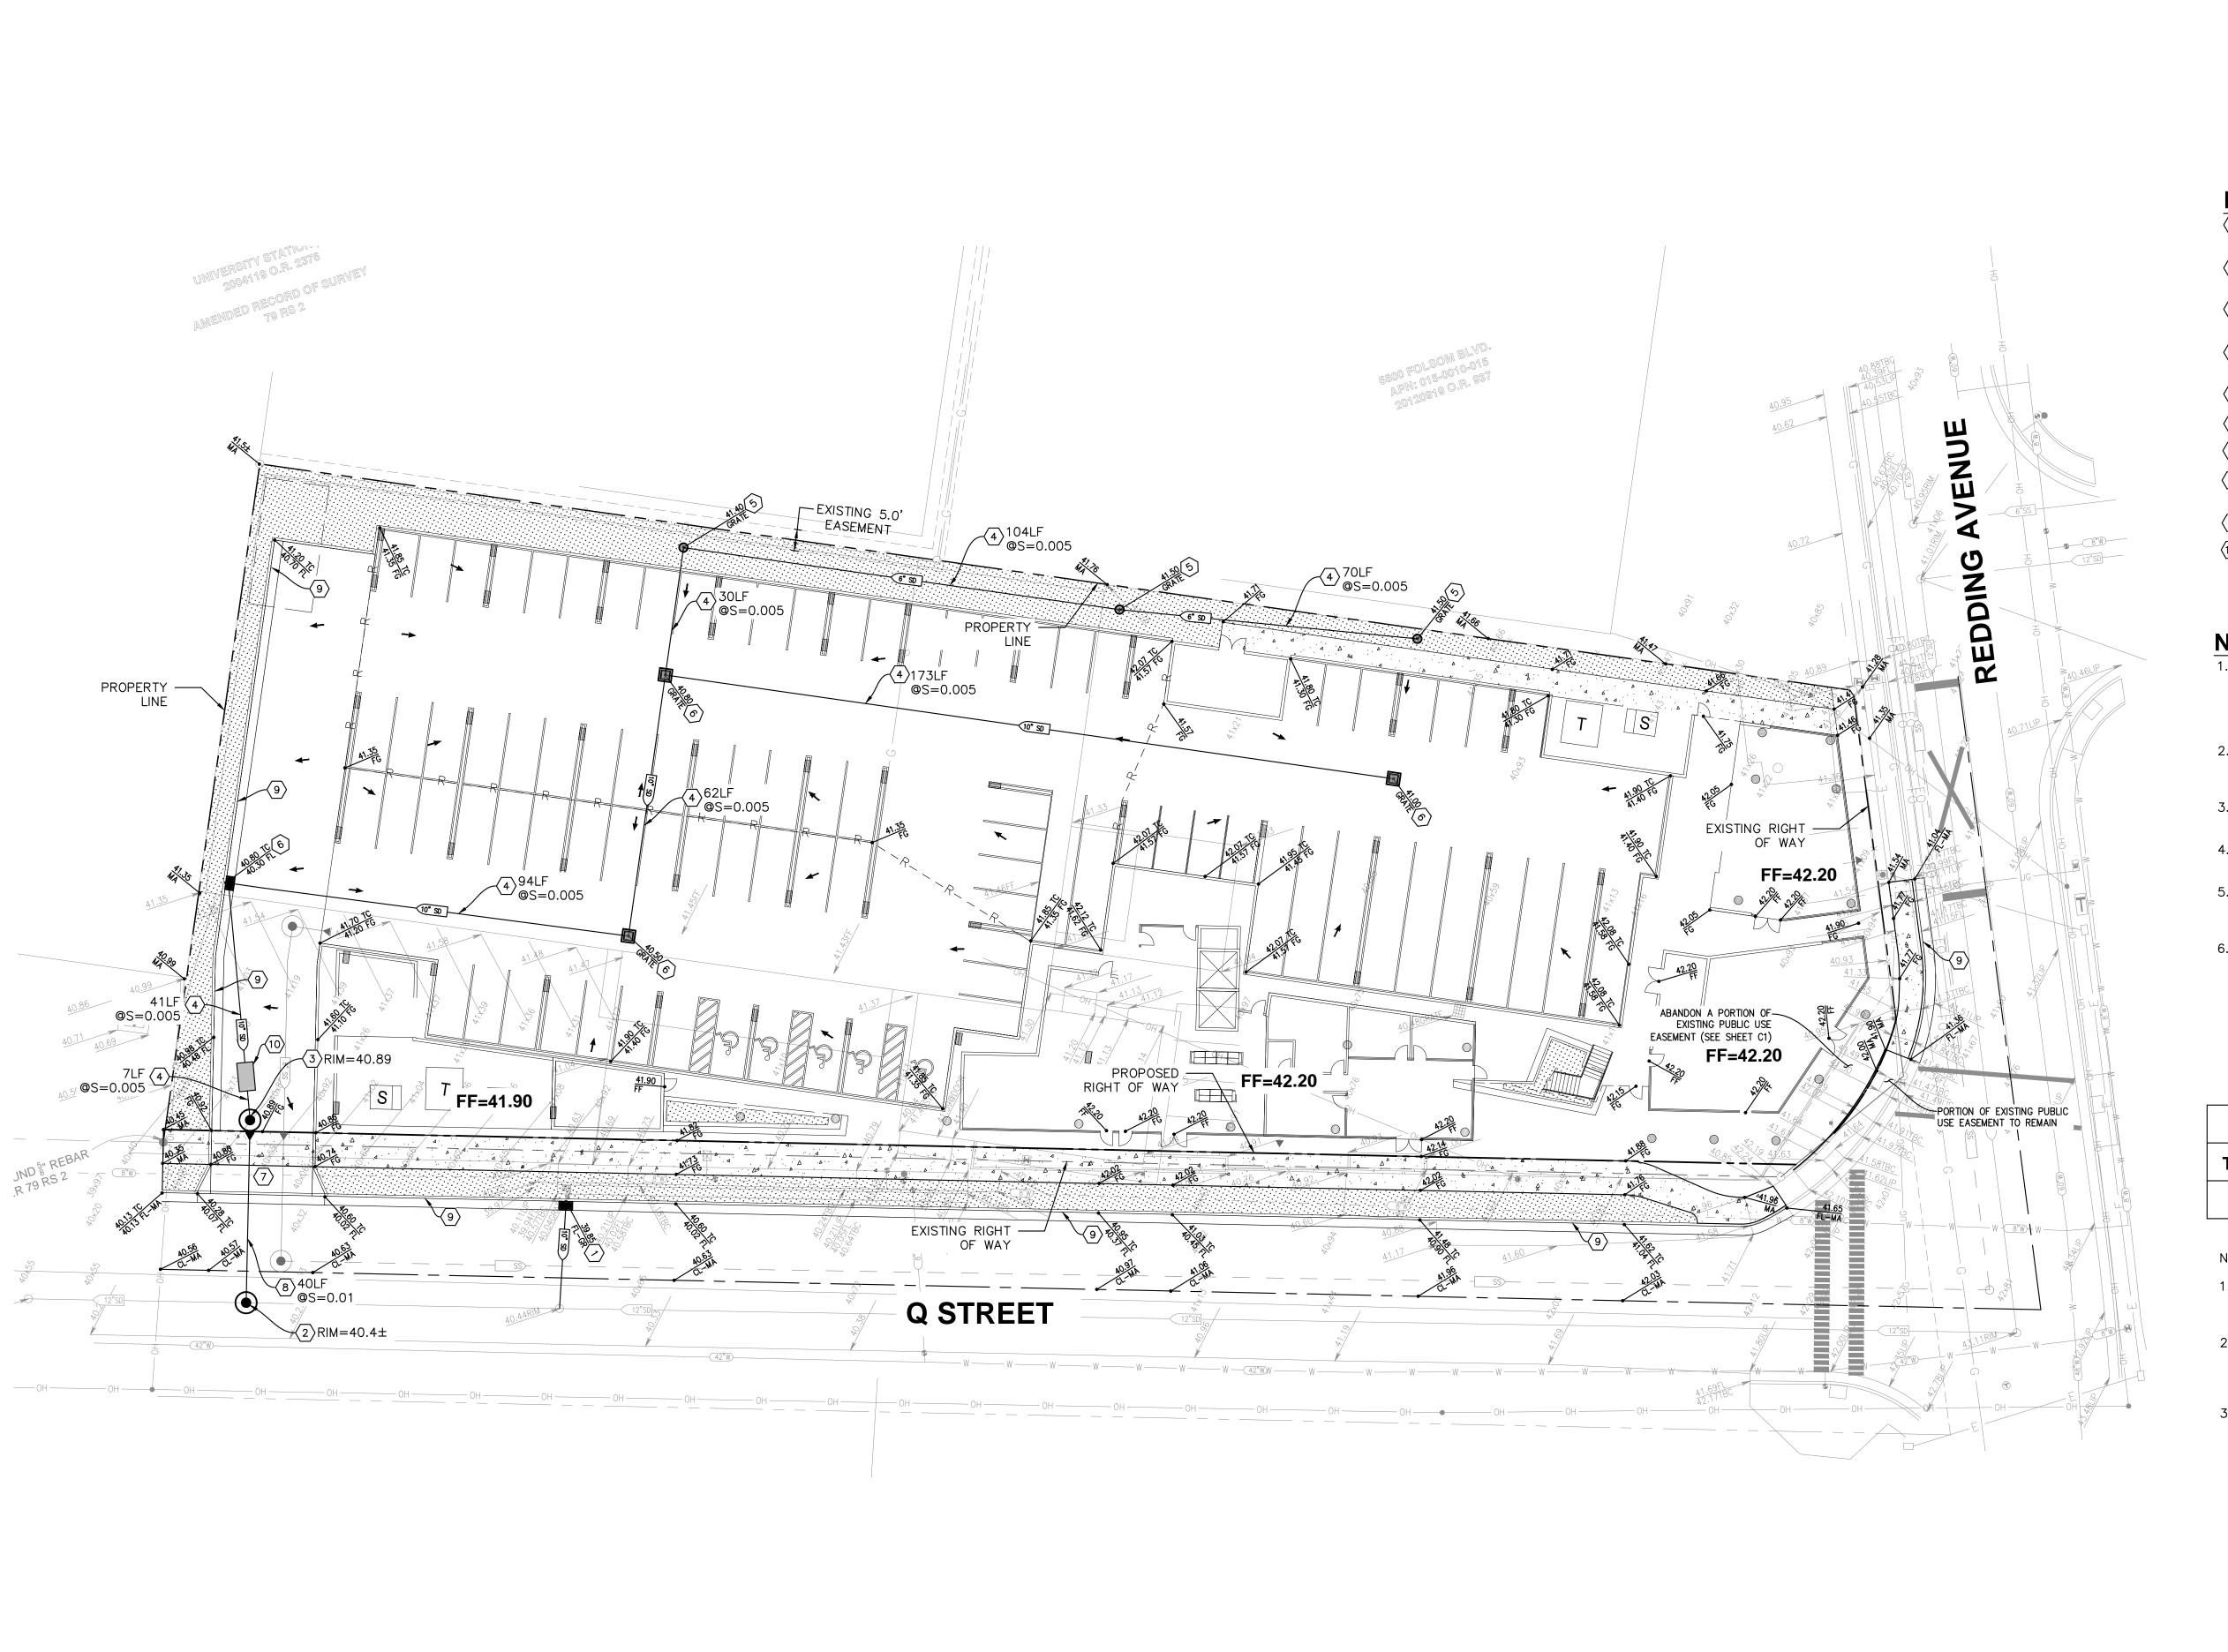

KEYNOTES

- 1 REMOVE EXISTING DRAIN INLET AND INSTALL MODIFIED TYPE B INLET AND LEADER.
- 2 INSTALL NEW STANDARD MANHOLE NO. 3 PER CITY OF SACRAMENTO STANDARD DWG. NO S-70.
- (3) INSTALL NEW STANDARD MANHOLE NO. 3 WITH TRAP AND SUMP PER CITY OF SACRAMENTO STANDARD DWG. NO. S-90.
- (4) INSTALL PRIVATE STORM DRAIN LINE PER CITY OF SACRAMENTO STANDARDS. SIZE, SLOPE AND LENGTH PER PLAN.
- (5) INSTALL LANDSCAPE DRAIN.
- $\langle 6 \rangle$ INSTALL DRAIN INLET.
- $\langle 7 \rangle$ INSTALL NEW DRIVEWAY PER CITY OF SACRAMENTO DETAIL T-22.
- (8) INSTALL 10" PVC SDR STORM DRAIN SERVICE TO CITY RIGHT OF WAY PER CITY OF SACRAMENTO STANDARDS.
- (9) INSTALL TYPE 2 CURB AND GUTTER.
- 10 UNDERGROUND STORMWATER QUALITY MECHANICAL SYSTEM.


NOTES

- 1. THIS PRELIMINARY GRADING AND DRAINAGE PLAN WAS PREPARED TO DEPICT PROPOSED GRADING AND DRAINAGE CONCEPTS AS REQUIRED FOR THE ENTITLEMENT PROCESS. ACTUAL FINAL DESIGN MAY VARY FROM THAT SHOWN HERON AS THE DESIGN PROCESS PROGRESSES.
- 2. THIS EXHIBIT IS BASED ON THE PRELIMINARY Q STREET COMMONS SITE PLAN PREPARED BY MEEKS + PARTNERS DATED APRIL 2018.
- 3. PROPOSED ELEVATIONS SHOWN ARE ESTIMATES ONLY. ACTUAL ELEVATIONS MAY CHANGE DURING FINAL DESIGN.
- 4. BOUNDARY AND TOPOGRAPHIC SURVEY PREPARED BY MORROW SURVEYING DATED JUNE 2017.
- 5. EXISTING UTILITY IMPROVEMENTS ARE BASED ON AVAILABLE CITY BASE UTILITY MAPS. ACTUAL SIZES, TYPES AND LOCATIONS MAY VARY FROM INFORMATION SHOWN HEREON.
- 6. NO EXISTING ON-SITE DRAINAGE COURSES, ETC.

IMPERVIOUS SURFACE								
TOTAL SITE AREA	EXISTING	PROPOSED						
52,930 SF	52,930 SF	50,113 SF						

NOTES:

- PROPOSED IMPERVIOUS SURFACE AREAS SHOWN ARE APPROXIMATE AND WILL VARY AS THE DESIGN PROCESS DEVELOPS.
- THE EXISTING PROJECT SITE IS 100% IMPERVIOUS. THERE IS NO INCREASE IN IMPERVIOUS AREA TO THE SITE, THEREFORE, IT IS ASSUMED THAT NO MITIGATION OF DRAINAGE IMPACT WILL BE REQUIRED.
- STORM WATER QUALITY MITIGATION MEASURES WILL BE PROVIDED BY AN UNDERGROUND MECHANICAL SYSTEM OR OTHER APPROVED METHOD.

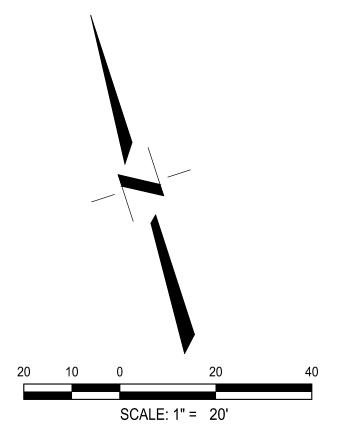


PLAN NOMMO GRADING SITE

Q

C2


DATE: __04/20/18

JOB NO: 1672.04

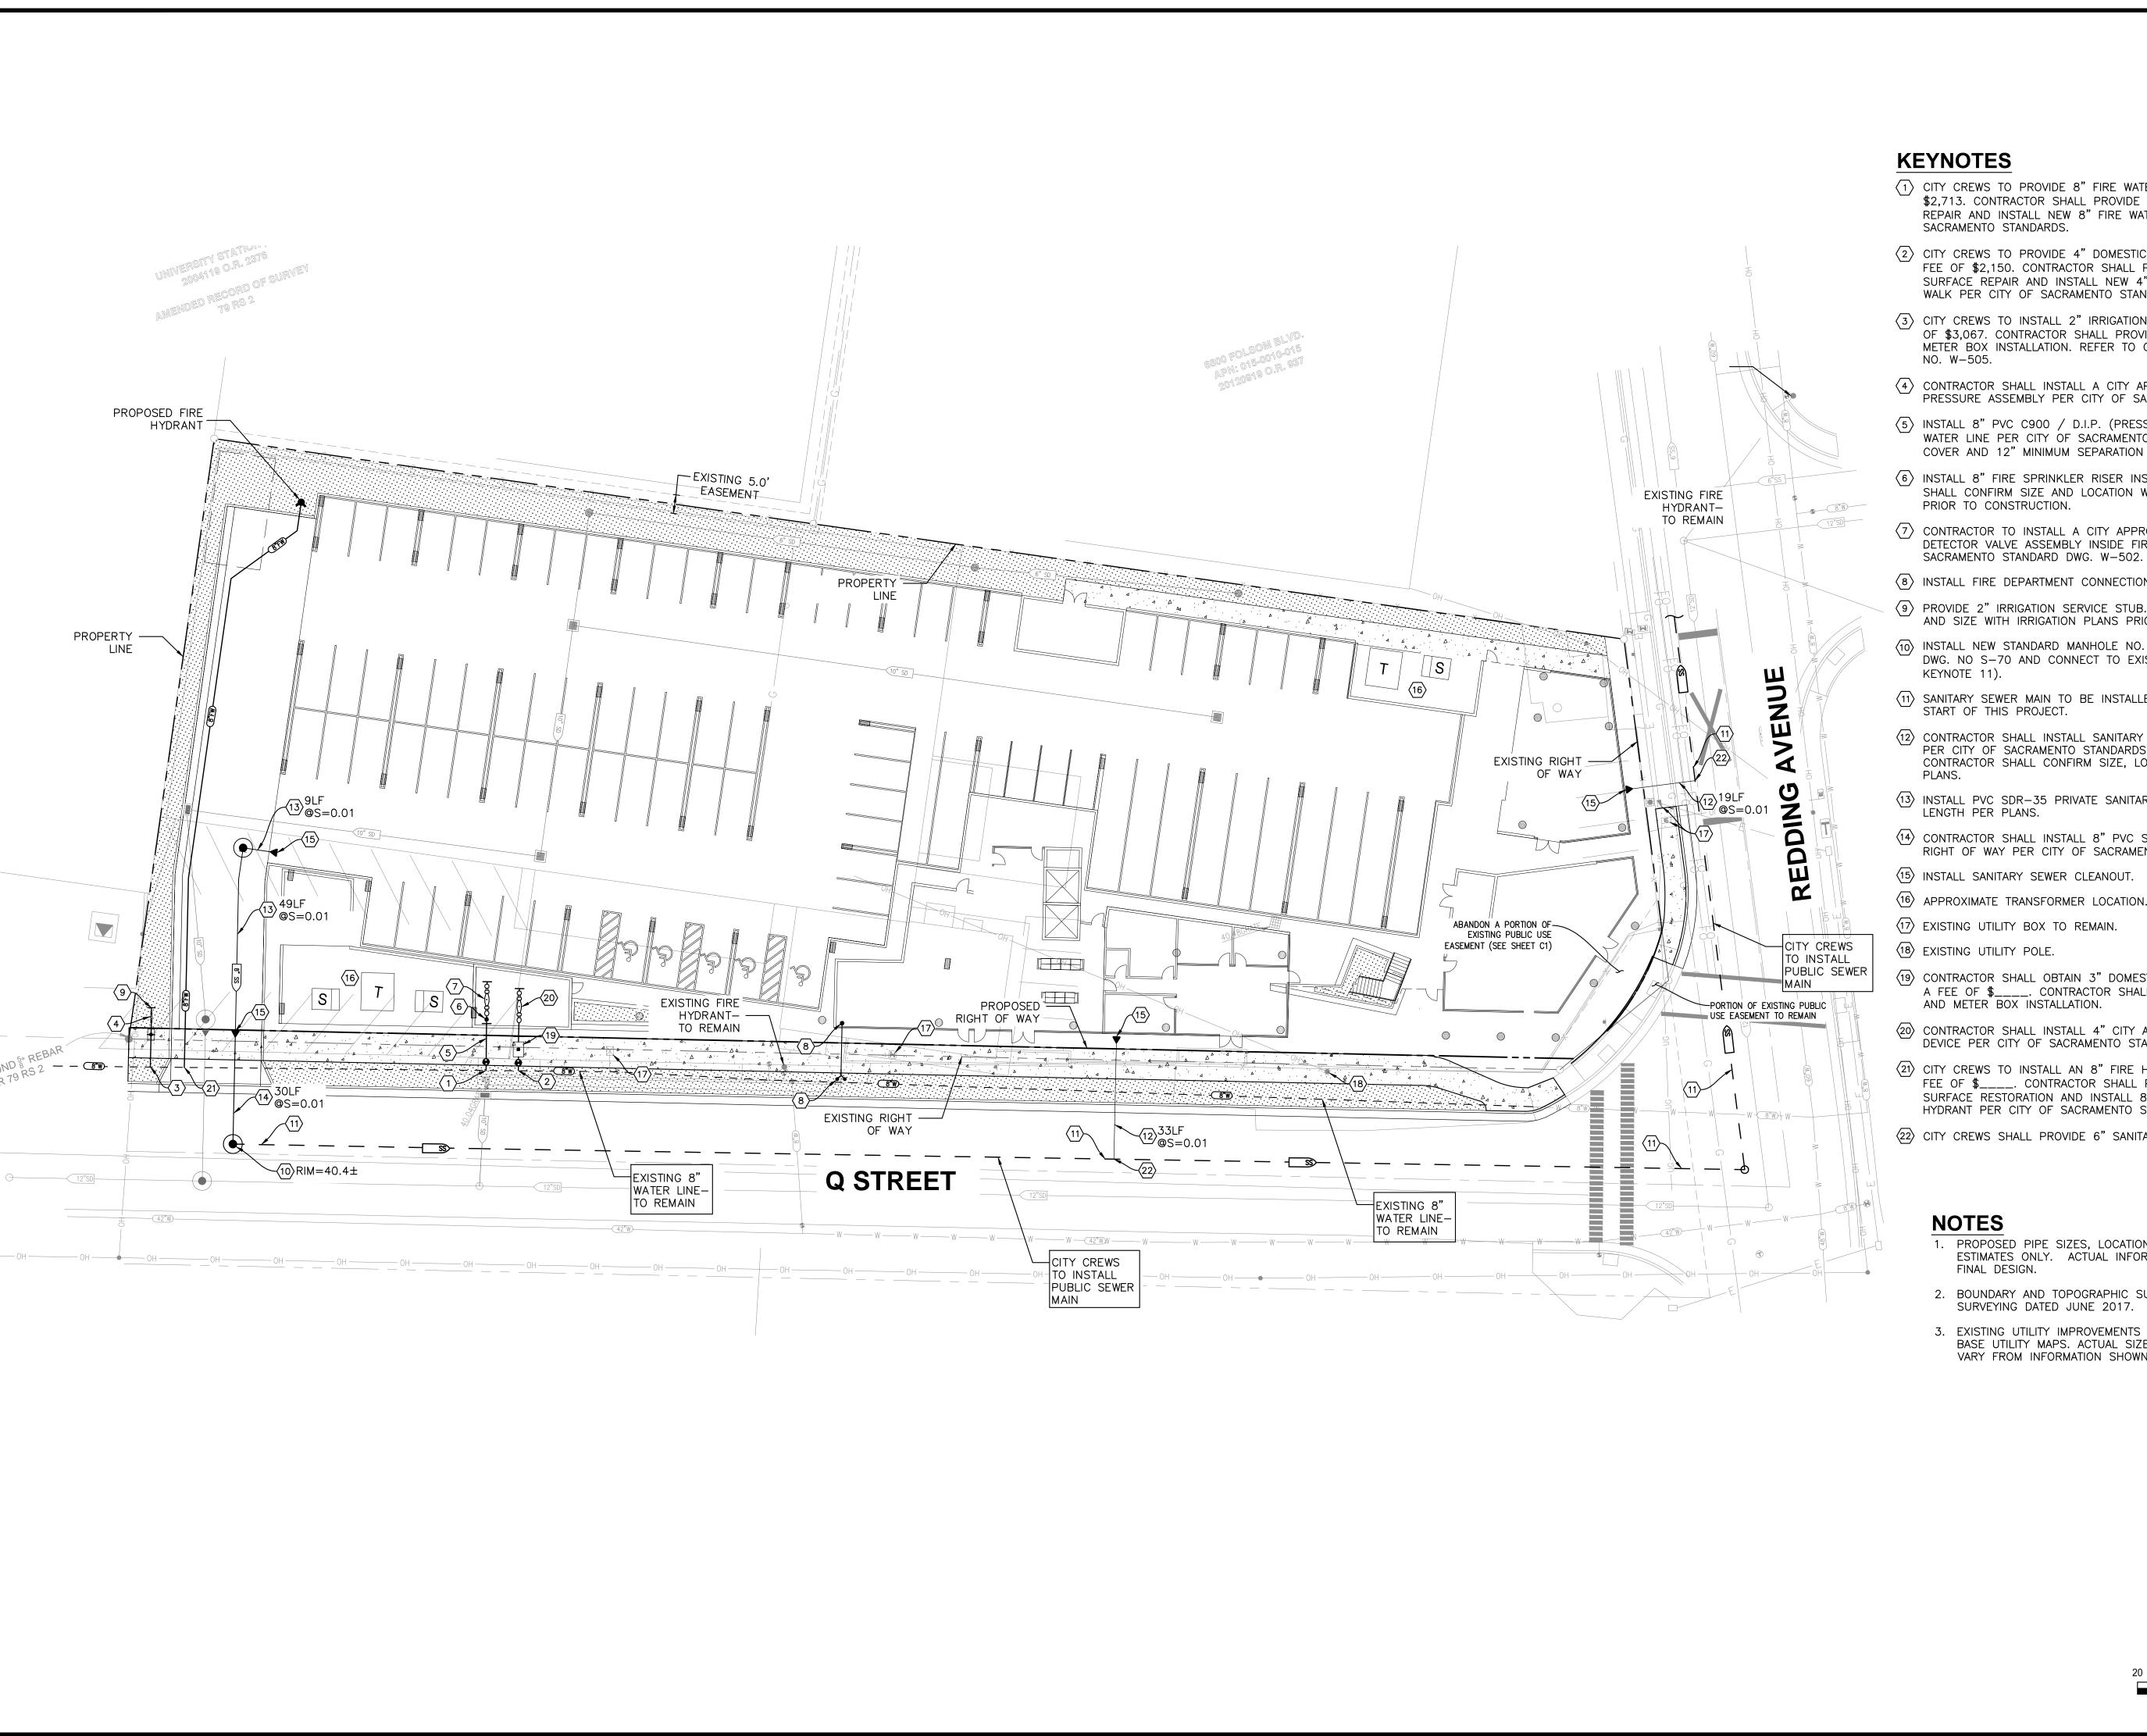

- (1) CITY CREWS TO PROVIDE 8" FIRE WATER TAP AND GATE VALVE FOR A FEE OF \$2,713. CONTRACTOR SHALL PROVIDE ALL EXCAVATION, BACKFILL, SURFACE REPAIR AND INSTALL NEW 8" FIRE WATER SERVICE TO BUILDING PER CITY OF
- (2) CITY CREWS TO PROVIDE 4" DOMESTIC WATER TAP AND GATE VALVE FOR A FEE OF \$2,150. CONTRACTOR SHALL PROVIDE ALL EXCAVATION, BACKFILL, SURFACE REPAIR AND INSTALL NEW 4" DOMESTIC WATER SERVICE TO BACK OF WALK PER CITY OF SACRAMENTO STANDARDS.
- (3) CITY CREWS TO INSTALL 2" IRRIGATION TAP, SERVICE AND METER FOR A FEE OF \$3,067. CONTRACTOR SHALL PROVIDE ALL EXCAVATION, BACKFILL, AND METËR BOX INSTALLATION. REFER TO CITY OF SACRAMENTO STANDARD DWG.
- (4) CONTRACTOR SHALL INSTALL A CITY APPROVED 2" IRRIGATION WATER REDUCED PRESSURE ASSEMBLY PER CITY OF SACRAMENTO STANDARD DWG. NO. W-505.
- (5) INSTALL 8" PVC C900 / D.I.P. (PRESSURE RATING 200 PSI MINIMUM) FIRE WATER LINE PER CITY OF SACRAMENTO STANDARDS. MAINTAIN 36" MINIMUM COVER AND 12" MINIMUM SEPARATION FROM OTHER UTILITIES.
- (6) INSTALL 8" FIRE SPRINKLER RISER INSIDE FIRE RISER ROOM. CONTRACTOR SHALL CONFIRM SIZE AND LOCATION WITH FIRE SPRINKLER/PLUMBING PLANS
- (7) CONTRACTOR TO INSTALL A CITY APPROVED 8" FIRE WATER DOUBLE CHECK DETECTOR VALVE ASSEMBLY INSIDE FIRE RISER ROOM PER CITY OF
- (8) INSTALL FIRE DEPARTMENT CONNECTION DEVICE.
- 9 PROVIDE 2" IRRIGATION SERVICE STUB. CONTRACTOR SHALL CONFIRM LOCATION AND SIZE WITH IRRIGATION PLANS PRIOR TO CONSTRUCTION.
- (10) INSTALL NEW STANDARD MANHOLE NO. 3 PER CITY OF SACRAMENTO STANDARD DWG. NO S-70 AND CONNECT TO EXISTING SANITARY SEWER LINE (SEE
- (11) SANITARY SEWER MAIN TO BE INSTALLED BY CITY OF SACRAMENTO, PRIOR TO
- (12) CONTRACTOR SHALL INSTALL SANITARY SEWER SERVICE @ S=0.01 (MINIMUM) PER CITY OF SACRAMENTO STANDARDS TO WITHIN 5 FEET OF BUILDING WALL. CONTRACTOR SHALL CONFIRM SIZE, LOCATION, AND INVERT WITH PLUMBING
- (13) INSTALL PVC SDR-35 PRIVATE SANITARY SEWER LINE. SIZE, SLOPE AND LENGTH PER PLANS.
- (14) CONTRACTOR SHALL INSTALL 8" PVC SDR SANITARY SEWER SERVICE TO CITY RIGHT OF WAY PER CITY OF SACRAMENTO STANDARDS.
- (15) INSTALL SANITARY SEWER CLEANOUT.


- (19) CONTRACTOR SHALL OBTAIN 3" DOMESTIC WATER METER FROM TEH CITY FOR A FEE OF \$____. CONTRACTOR SHALL PROVIDE ALL EXCAVATION, BACKFILL, AND METER BOX INSTALLATION.
- (20) CONTRACTOR SHALL INSTALL 4" CITY APPROVED DOMESTIC WATER BACKFLOW DEVICE PER CITY OF SACRAMENTO STANDARDS.
- (21) CITY CREWS TO INSTALL AN 8" FIRE HYDRANT TAP AND GATE VALVE FOR A FEE OF \$____. CONTRACTOR SHALL PROVIDE ALL EXCAVATION, BACKFILL, SURFACE RESTORATION AND INSTALL 8" FIRE HYDRANT LEAD AND FIRE HYDRANT PER CITY OF SACRAMENTO STANDARD DWG. W-201.
- (22) CITY CREWS SHALL PROVIDE 6" SANITARY SEWER TAP FOR A FEE OF \$____.
 - 1. PROPOSED PIPE SIZES, LOCATIONS AND INVERTS SHOWN ARE ESTIMATES ONLY. ACTUAL INFORMATION MAY CHANGE DURING
 - 2. BOUNDARY AND TOPOGRAPHIC SURVEY PREPARED BY MORROW SURVEYING DATED JUNE 2017.
 - 3. EXISTING UTILITY IMPROVEMENTS ARE BASED ON AVAILABLE CITY BASE UTILITY MAPS. ACTUAL SIZES, TYPES AND LOCATIONS MAY VARY FROM INFORMATION SHOWN HEREON.

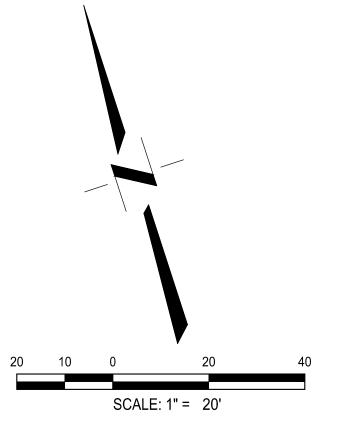

COMMON: ITY PLAN EET U Q STR SITE

C3

DATE: _ 04/20/18 JOB NO: 1672.04

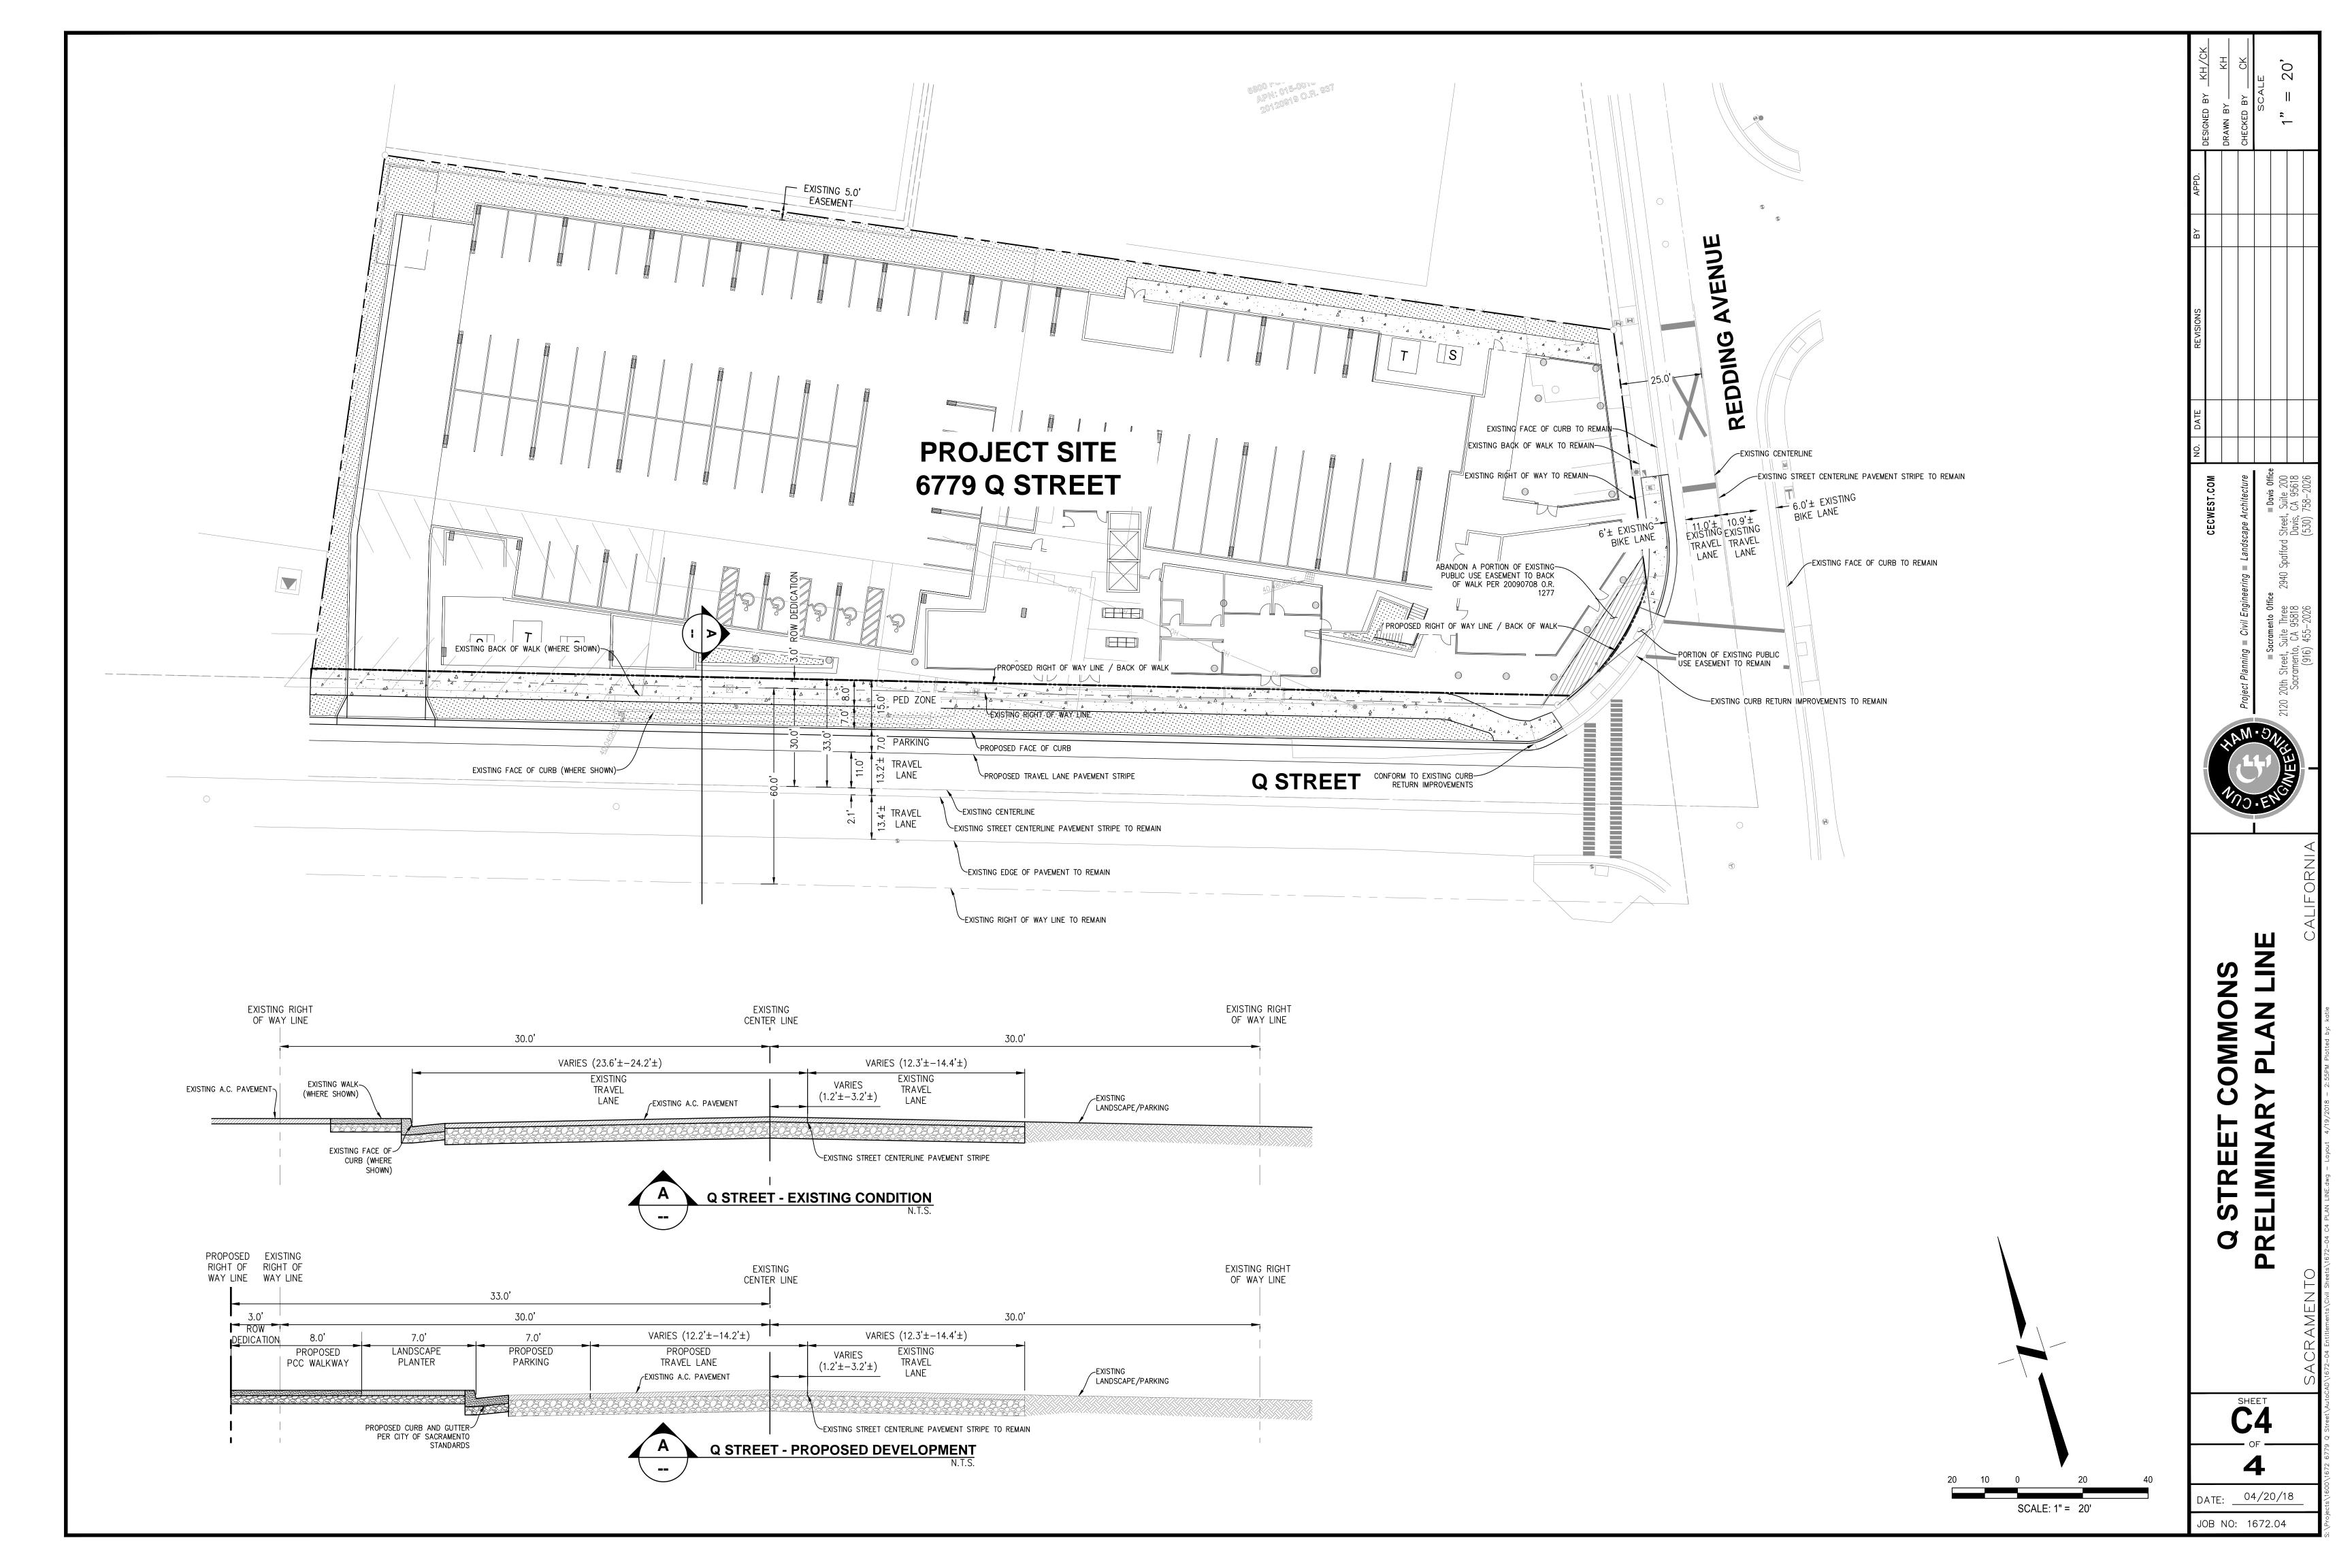

PLANTING	LEG	END											<u> </u>
TREES	CODE	BOTANICAL NAME	COMMON NAME	CONTAINER SIZE	MATER USE	<u>HXM</u>	ORNAMENTAL GRASSES	CODE	BOTANICAL NAME	COMMON NAME	CONT	MATER USE	HXM
E TO THE STATE OF	PIS KEI	Pistacia chinensis 'Keith Davey'	Keith Davey Chinese Pistache	15 gal		30'x30'	0	CAL KAR	Calamagrostis x acutiflora 'Karl Foerster'	Feather Reed Grass	l gal	L	4'X3'
GROUNDCOVERS	CODE	BOTANICAL NAME	COMMON NAME	CONT	MATER USE	HXM		MUH RIG	Muhlenbergia rigens	Deer Grass	5 gal		4'X4'
	JUN BUF	Juniperus sabina 'Buffalo'	Buffalo Juniper	l gal	L	1'X6'	SMALL SHRUBS	CODE	BOTANICAL NAME	COMMON NAME	CONT	MATER USE	HXM
~	LAN MH2	Lantana montevidensis 'White Lightnin'	Trailing Lantana	l gal	L	1'X5'	O	CEA VAL	Ceanothus maritimus 'Valley Violet'	Maritime Ceanothus	l gal	L	2'X4'
LARGE SHRUBS	CODE	BOTANICAL NAME	COMMON NAME	CONT	MATER USE	HXM		CIS SAL	Cistus salviifolius	Rockrose Sageleaf	l gal	L	2'X6'
O	ACA MOL	Acanthus mollis	Bear's Breech	l gal	М	4'X4'		EPI CAR	Epilobium canum 'Carmen's Grey'	Carmen's Grey California Fuchsia	l gal	L	2'X4'
	NAN COM	Nandina domestica 'Compacta'	Dwarf Heavenly Bamboo	l gal	L	4'X3'		MAH OR2	Mahonia aquifolium 'Orange Flame'	Oregon Grape	5 gal	L	2'X3'
MEDIUM SHRUBS	CODE	BOTANICAL NAME	COMMON NAME	CONT	MATER USE	<u>HXM</u>		RHA BA4	Rhaphiolepis indica 'Ballerina'	Ballerina Indian Hawthorn	l gal	М	2'X4'
③	MAH COM	Mahonia aquifolium 'Compacta'	Compact Oregon Grape	5 gal	L	3'X5'		SAL RED	Salvia greggii 'Red'	Autumn Sage	5 gal	L	2'X2'
	PHO SPR	Phormium tenax 'Dazzler'	New Zealand Flax	l gal	L	3'X5'							

2.5'X3'

PIT WHE Pittosporum tobira 'Wheelers Dwarf'

Wheeler's Dwarf Mock Orange



PLANTING NOTES

MATERIALS LARGER THAN 2".

- I. ALL LANDSCAPING SHALL BE PROVIDED AND PERFORMED IN ACCORDANCE WITH PLANS, DETAILS, AND SPECIFICATIONS.
- 2. ALL TREES AND SHRUBS WILL BE INSPECTED, ACCEPTED, OR REJECTED BASED ON CALIFORNIA STATE DEPARTMENT OF AGRICULTURE'S REGULATION FOR NURSERY INSPECTIONS, RULES, AND RATING. NO ROOT BOUND PLANTS SHALL BE USED, ONLY HEALTHY, WELL-FORMED, AND VIGOROUS PLANT MATERIAL SHALL BE
- 3. CONTRACTOR SHALL REMOVE LIME TREATED SOIL IN ALL PLANTING AREAS AND IMPORT PREFERRED LANDSCAPE PLANTING SOIL PRIOR TO IRRIGATION AND PLANTING.
- 4. ALL PLANTING AREAS SHALL BE AMENDED TO A DEPTH OF 6" MINIMUM PRIOR TO DIGGING PLANTING PITS PER RECOMMENDATIONS OF THE SOIL ANALYSIS. REFER TO SOIL ANALYSIS NOTES ON THIS SHEET.
- 5. ALL TREES & SHRUBS AT MATURITY SHALL HAVE A CLEARANCE OF THREE FEET (3') AROUND ANY ELECTRICAL BOXES, FIRE HYDRANTS, OR OTHER UTILITY BOXES. CONTRACTOR SHALL ADJUST AS REQUIRED IN FIELD.
- 6. ALL TREES SHALL HAVE A CLEARANCE OF TWELVE FEET (12') AROUND ANY LIGHT FIXTURES FROM CENTER OF
- 7. ROOT BARRIERS ARE TO BE INSTALLED ADJACENT TO ALL SIDEWALKS WITHIN 5'-O" OF TREE TRUNK FOR A LENGTH OF &' ON EACH SIDE OF THE TRUNK. SEE LANDSCAPE DETAILS.
- 8. ALL PLANTING AREAS SHALL BE COMPLETELY FREE OF TRASH, DEBRIS, ROCKS AND CONSTRUCTION

TREE TRUNK. CONTRACTOR SHALL ADJUST AS REQUIRED IN FIELD.

- 9. IF ADDITIONAL SOIL IS REQUIRED, IT SHALL BE APPROVED LOAM AS SIMILAR TO THE EXISTING SOIL AS POSSIBLE, FREE OF DEBRIS AND NOXIOUS WEEDS. PRIOR TO PLACING ADDITIONAL SOIL, DISC OR SCARIFY THE SUBGRADE TO A DEPTH OF AT LEAST &" TO PERMIT BONDING TO THE SUBGRADE. SPREAD AND ROTOTILL A ONE-INCH LAYER OF NEW SOIL, THEN PROCEED TO PLACE REMAINING SOIL AND ESTABLISH FINISH
- 10. AFTER AMENDING THE SOIL, PRIOR TO PLANTING, A PRE-EMERGENT SHALL BE APPLIED TO ALL PLANTING AREAS. USE SURFLAN, RONSTAR-G, OR APPROVED EQUAL. CONTRACTOR SHALL APPLY AS RECOMMENDED PER MANUFACTURER RECOMMENDATIONS.
- II. ALL PLANTING AREAS SHALL BE BROUGHT TO FINISH GRADE BEFORE PLANTING BEGINS. FINISH GRADE SHALL BE 3" BELOW SURFACE OF WALKS, CURBS, AND PAVED AREAS IN PLANTING AREAS WHERE BARK IS TO BE INSTALLED. GRADES SHALL BE FLUSH AT CATCH BASINS. SURFACES SHALL BE SLOPED WITH REGARD TO DRAINAGE REQUIREMENTS SO THAT WATER DOES NOT PUDDLE OR STAND.
- 12. ALL PLANTING AREAS SHALL HAVE POSITIVE DRAINAGE AWAY FROM ALL BUILDINGS, FENCES \$ OTHER STRUCTURES, AND FROM SIDEWALK TO CURB.
- 13. PLANT HOLES SHALL BE 3X WIDTH AND 1.5X DEPTH FOR SHRUBS AND 4X WIDTH AND 1.5X DEPTH TREES. BACKFILL FOR THE PLANT HOLES SHALL BE EXISTING SOIL WHICH HAS BEEN PREVIOUSLY AMENDED PER SOILS
- 14. BARK MULCH SHALL BE SPREAD IN ALL PLANTER AREAS AS FOLLOWS: TREE \$ SHRUB AREAS: 3" LAYER MIN. OF WALK-ON BARK. RAINGARDEN PLANTER AREAS: 2" OF SMALL NON FLOATING CHIPPED BARK MULCH PER LANDSCAPE DETAILS. MULCH SHALL BE FREE OF LARGE WOODY PIECES, SOIL, STONES, STICKS, DEBRIS OR OTHER FOREIGN MATTER. DO NOT INSTALL MULCH WITHIN 6" OF TREE TRUNKS, TYPICAL. ALL MULCH AREAS SHALL BE BOUNDED ON THEIR PERIMETER WITH RETENTION DEVICES SUCH AS BENDER BOARD, RAISED PAVEMENT OR SIMILAR BOARDERS AND ALL BOUNDARIES SHALL BE RAISED 4" ABOVE ADJACENT LANDSCAPE GRADE OR TO THE DEPTH OF THE MULCH.
- 15. ACCEPTANCE OF ALL NATIVE HYDRSEED AREAS WILL BE BASED ON UNIFORM COLOR AND ESTABLISHMENT OF HYDROSEED WITHOUT BARE SPOTS. IF HYDROSEED IS NOT ESTABLISHED PRIOR TO THE END OF THE MAINTENANCE PERIOD CONTRACTOR SHALL REPAIR HYDROSEED AREAS AND SHALL CONTINUE MAINTENANCE UNTIL HYDROSEED AREAS ARE ACCEPTED BY THE OWNER'S REPRESENTATIVE.
- CONTRACTOR SHALL FURNISH ALL LABOR, MATERIAL, EQUIPMENT, AND SERVICES REQUIRED TO MAINTAIN THE LANDSCAPE IN AN ATTRACTIVE CONDITION AS SPECIFIED HEREIN FOR A PERIOD OF 90 DAYS AFTER FINAL INSPECTION BY OWNER. MAINTENANCE PERIOD SHALL COMMENCE AFTER ALL PLANTING AND RELATED WORK HAS BEEN COMPLETED, AS DETERMINED AT FINAL INSPECTION IN ACCORDANCE WITH THE PLANS AND STANDARD SPECIFICATIONS.
- 17. SPECIAL WARRANTY: WARRANT THE FOLLOWING LIVING PLANT MATERIALS FOR THE FOLLOWING SPECIFIED TIME PERIOD AFTER DATE OF SUBSTANTIAL COMPLETION, AGAINST DEFECTS INCLUDING DEATH AND UNSATISFACTORY GROWTH, EXCEPT FOR DEFECTS RESULTING FROM LACK OF ADEQUATE MAINTENANCE, NEGLECT, OR ABUSE BY OWNER, ABNORMAL WEATHER CONDITIONS UNUSUAL FOR WARRANTY PERIOD, OR INCIDENTS THAT ARE BEYOND CONTRACTOR'S CONTROL. I) TREES - I YEAR 2) SHRUBS - 6 MONTHS

3) GROUND COVERS - LENGTH OF MAINTENANCE


- REMOVE AND REPLACE DEAD PLANTING MATERIALS IMMEDIATELY UNLESS REQUIRED TO PLANT IN THE SUCCEEDING PLANTING SEASON. REPLACE PLANTING MATERIALS THAT ARE IN A SUBSTANTIALLY UNHEALTHY CONDITION (MORE THAN 25% OF THE PLANT DEAD OR REMOVED DUE TO DEATH OF BRANCHES, ETC.) AT THE END OF THE WARRANTY PERIOD.
- 19. A LIMIT OF ONE REPLACEMENT OF EACH PLANT MATERIAL WILL BE REQUIRED, EXCEPT FOR LOSSES OR REPLACEMENTS DUE TO FAILURE TO COMPLY WITH REQUIREMENTS.


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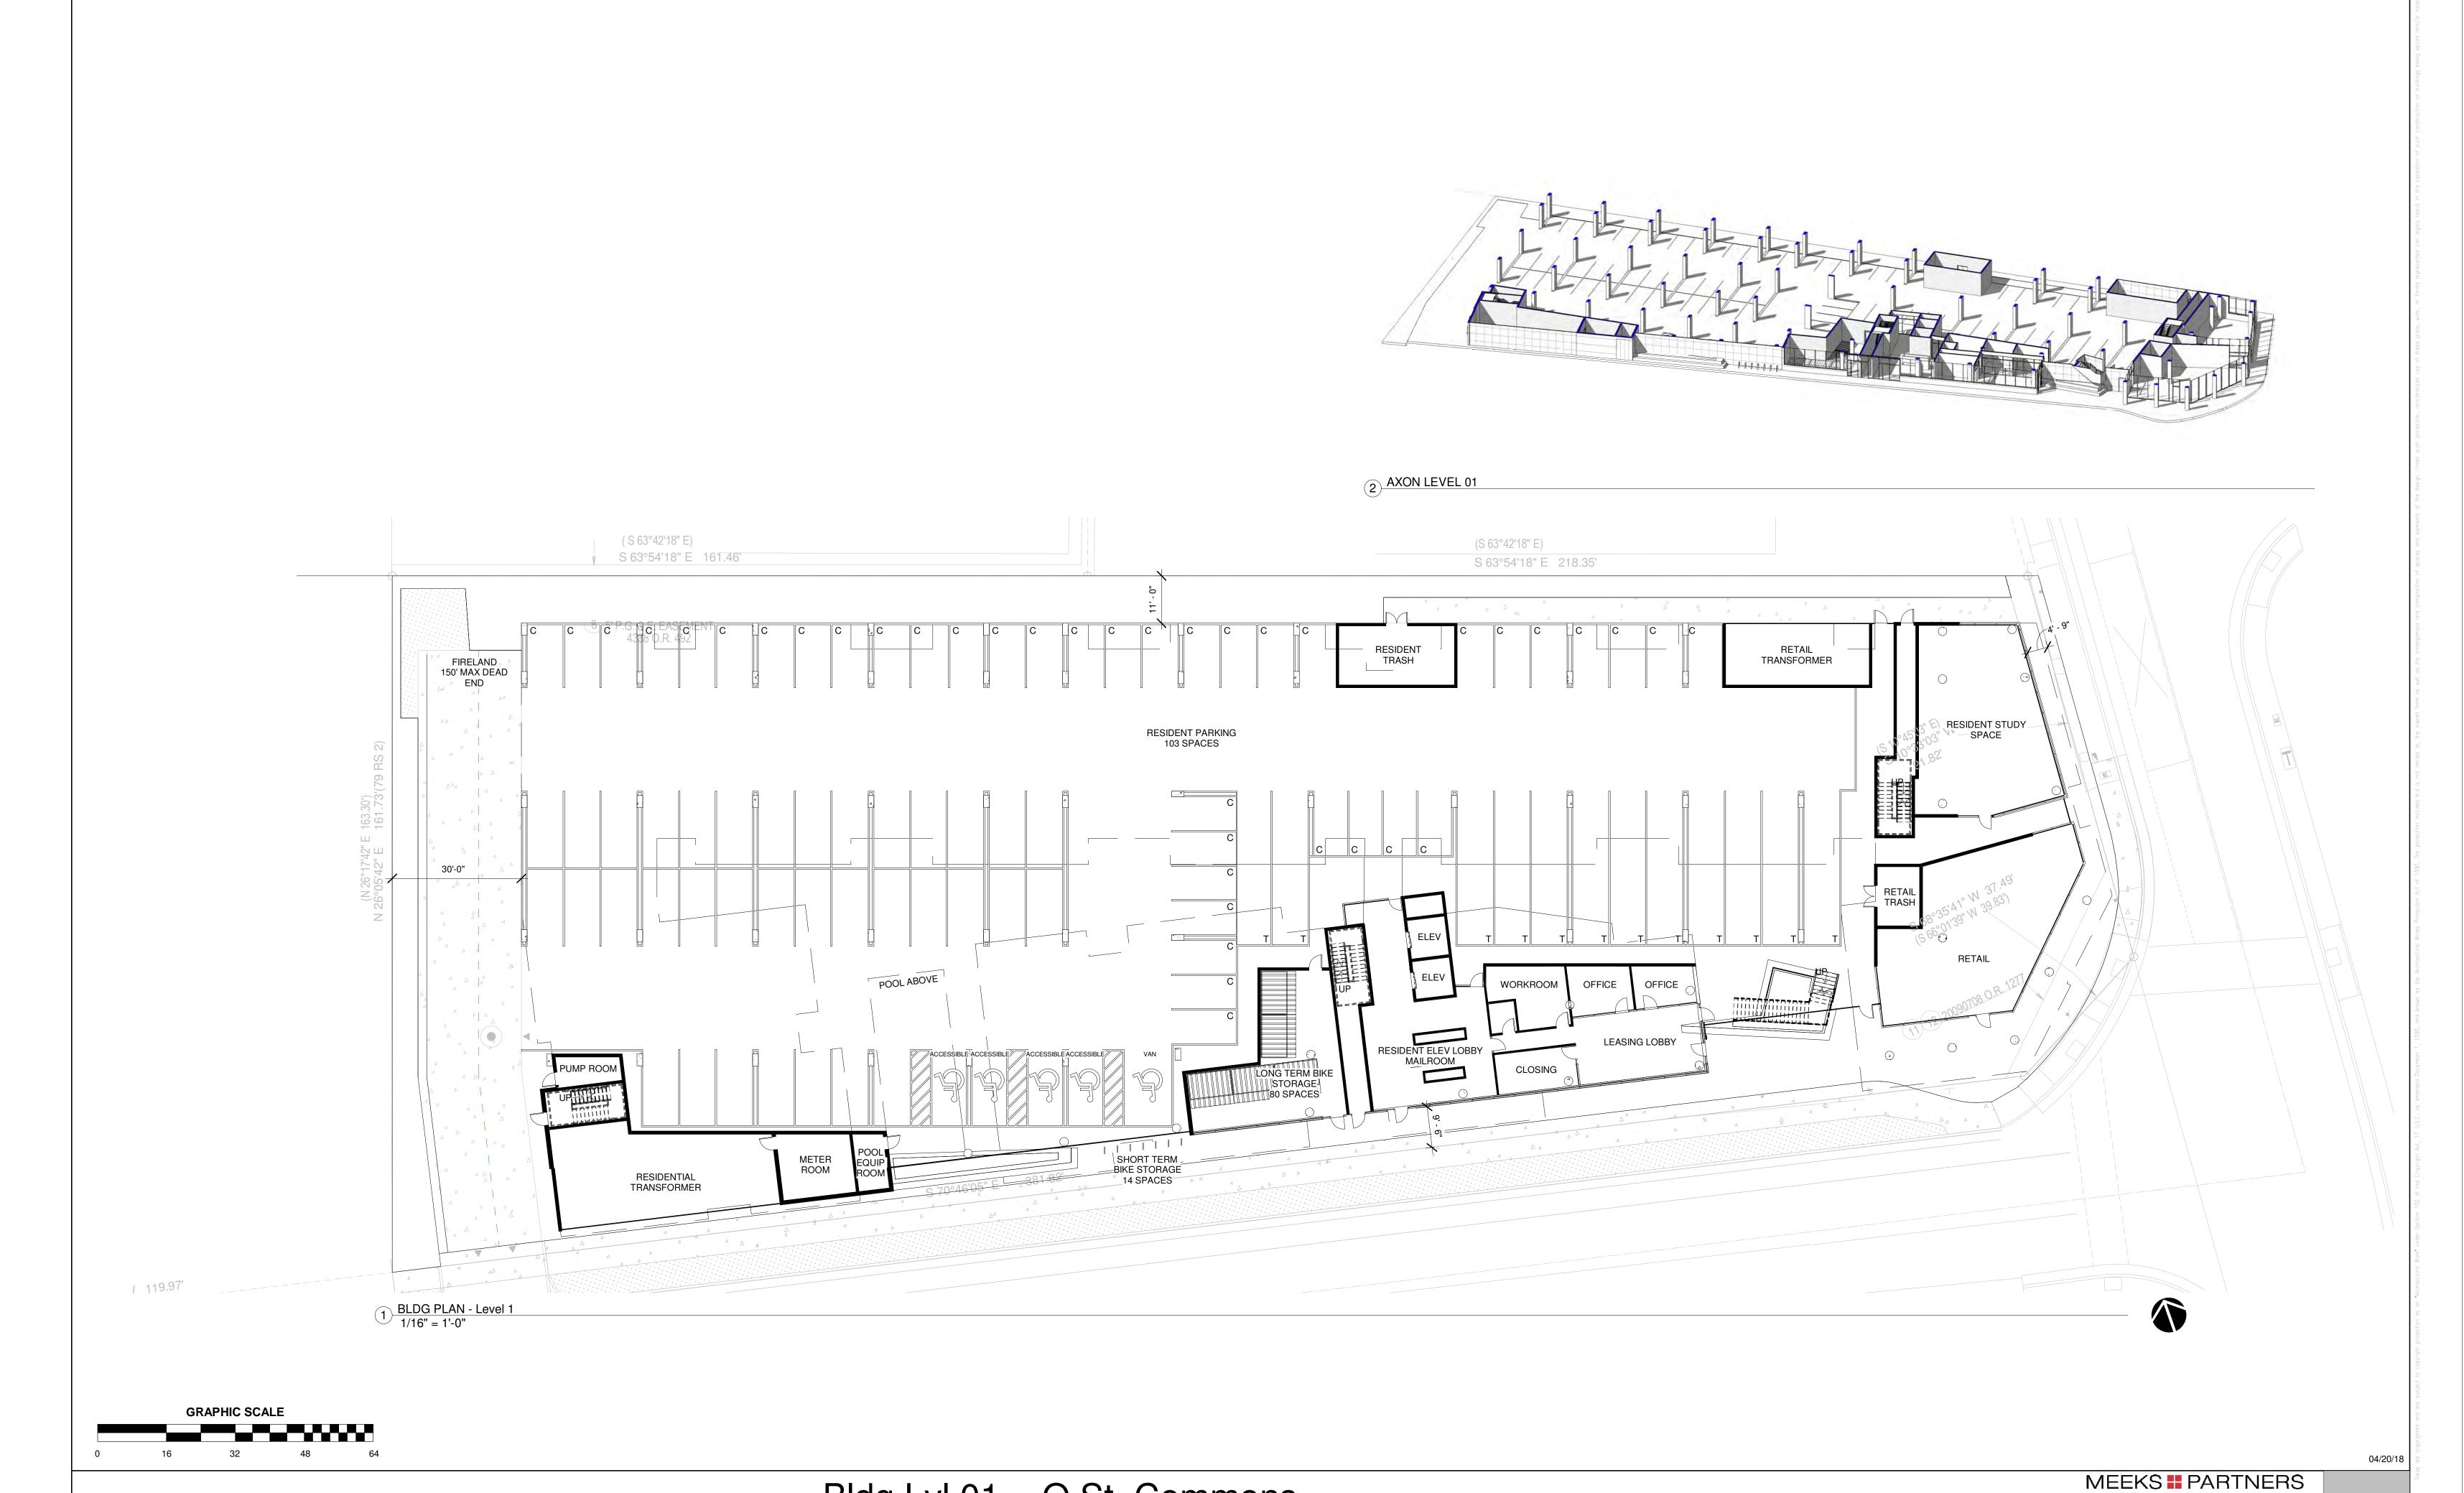
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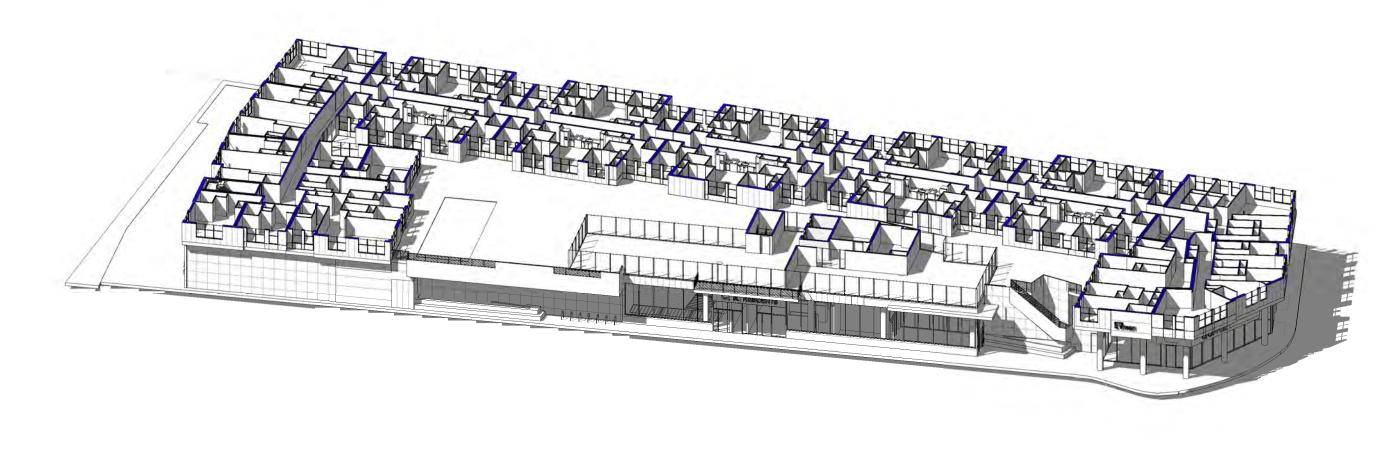
DATE: 04/20/18 JOB NO: 1672.04

SCALE: 1" = 20'





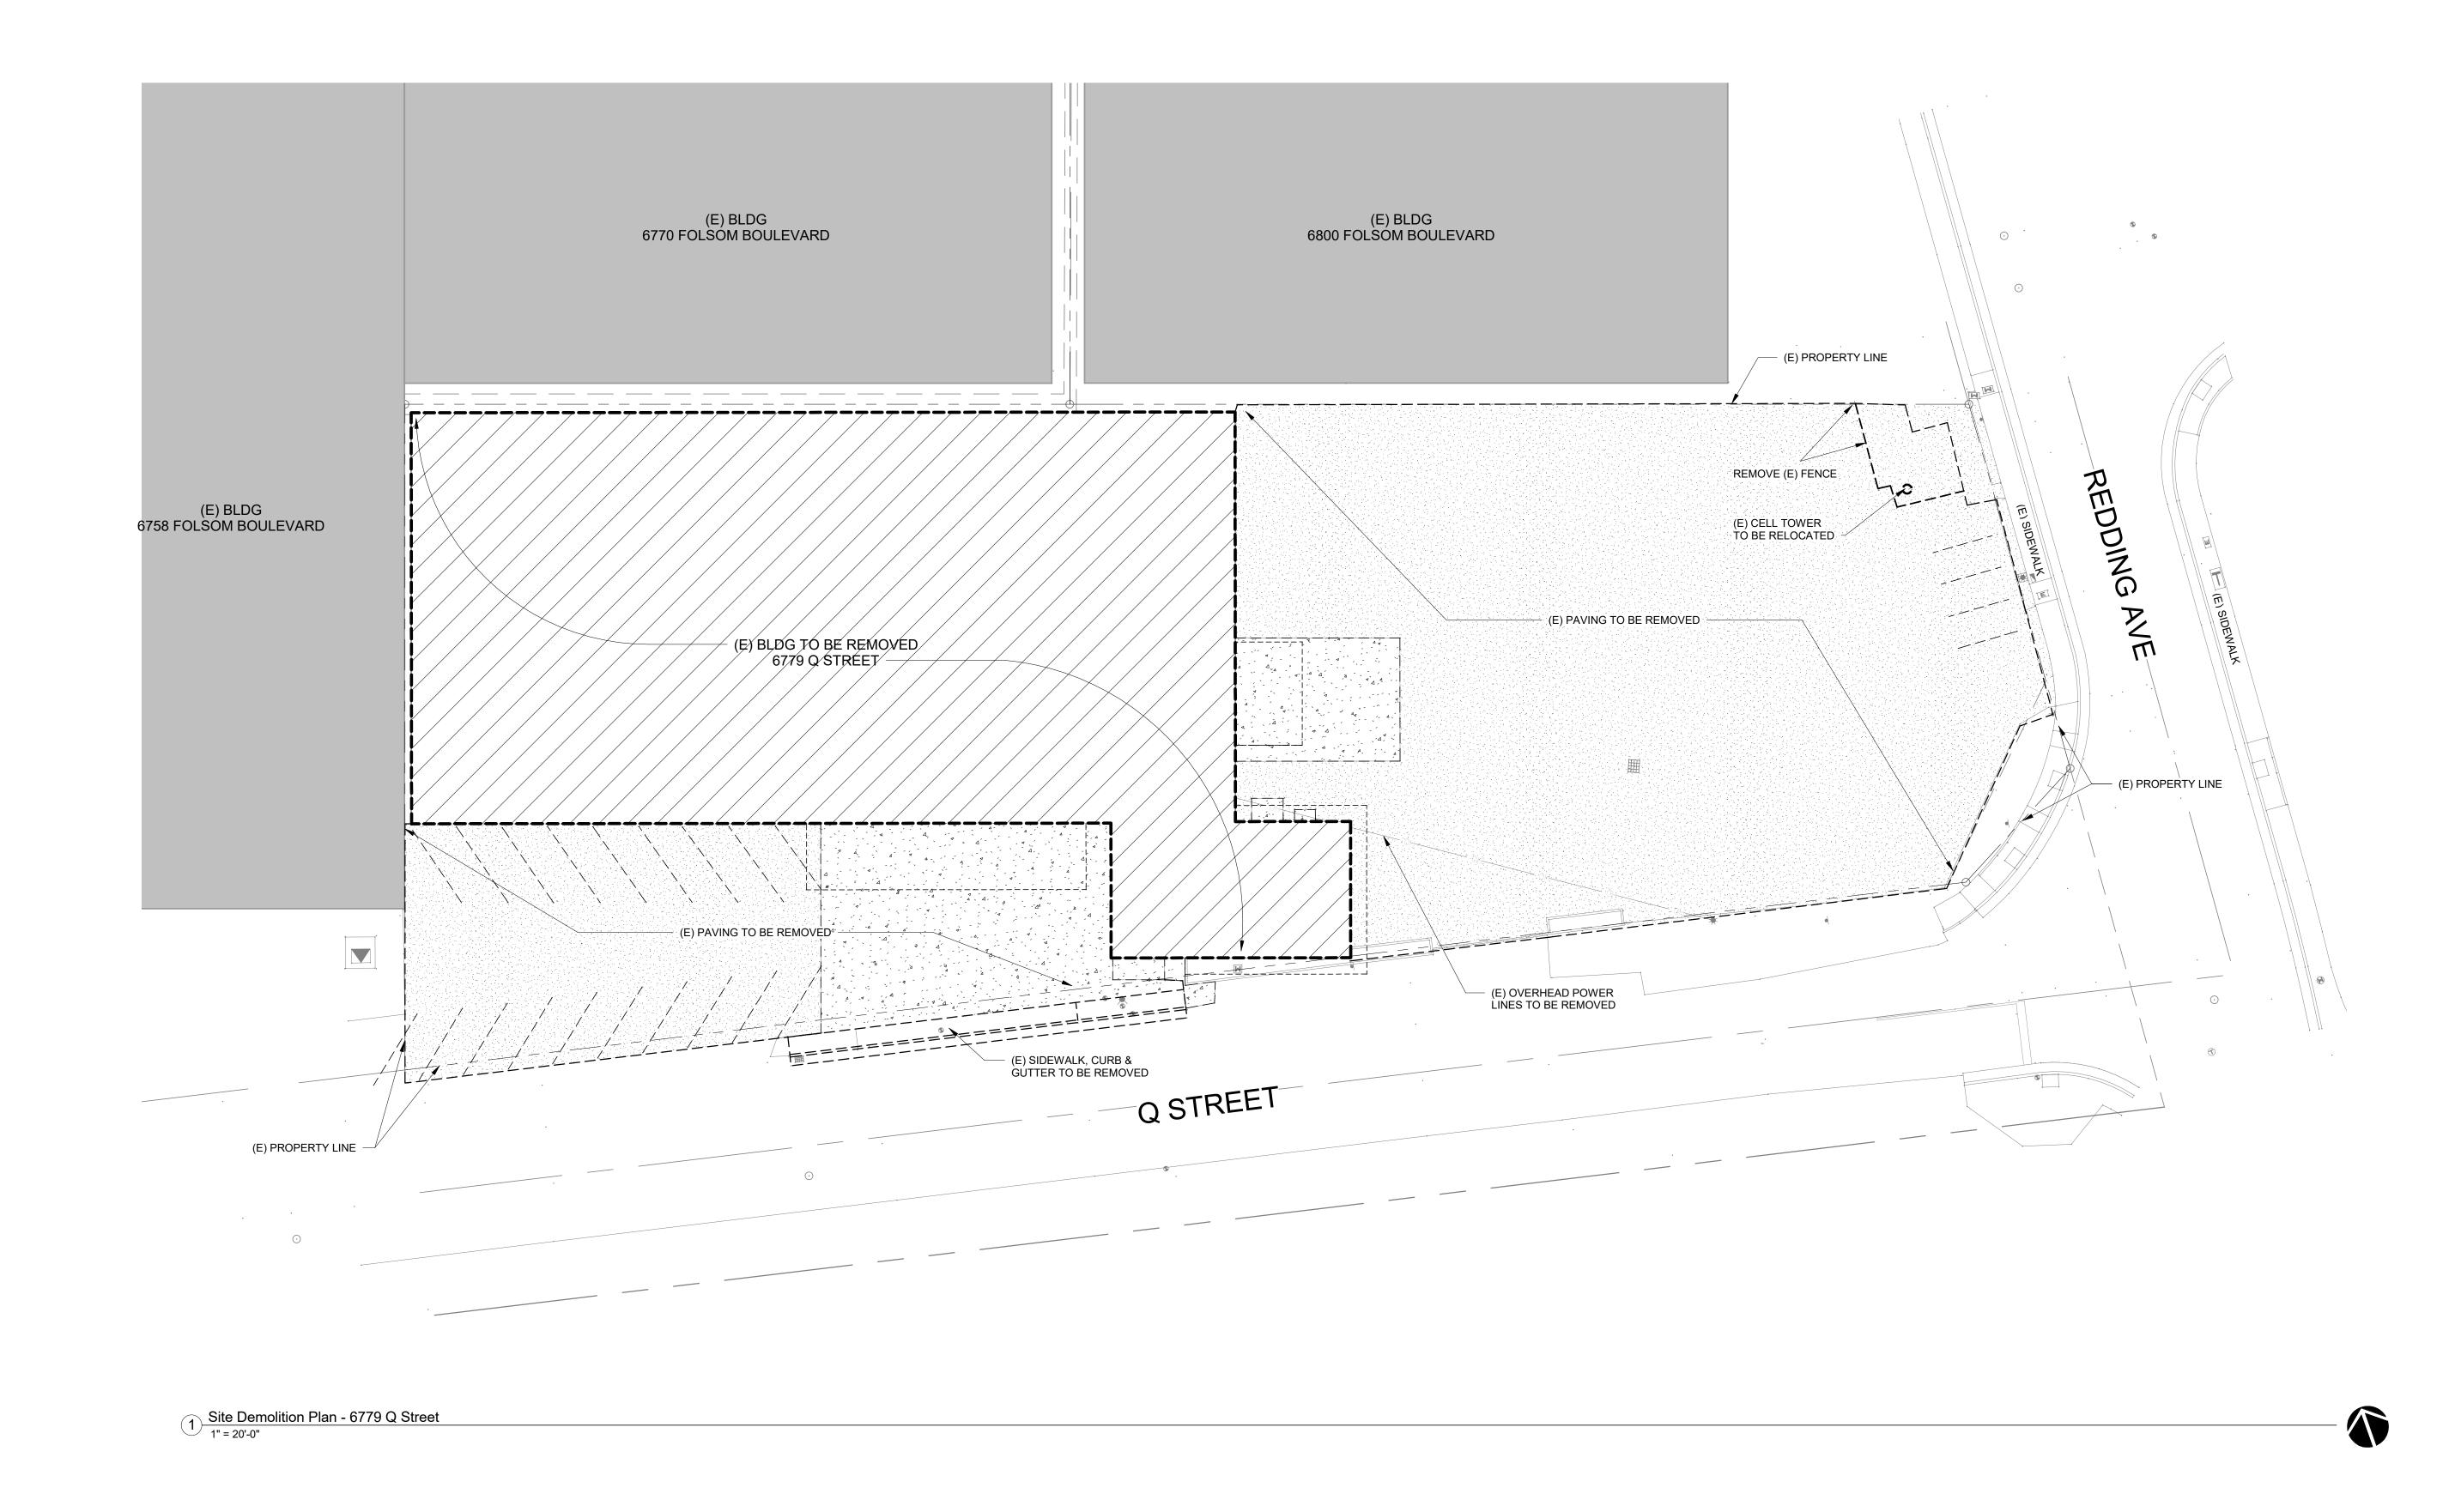

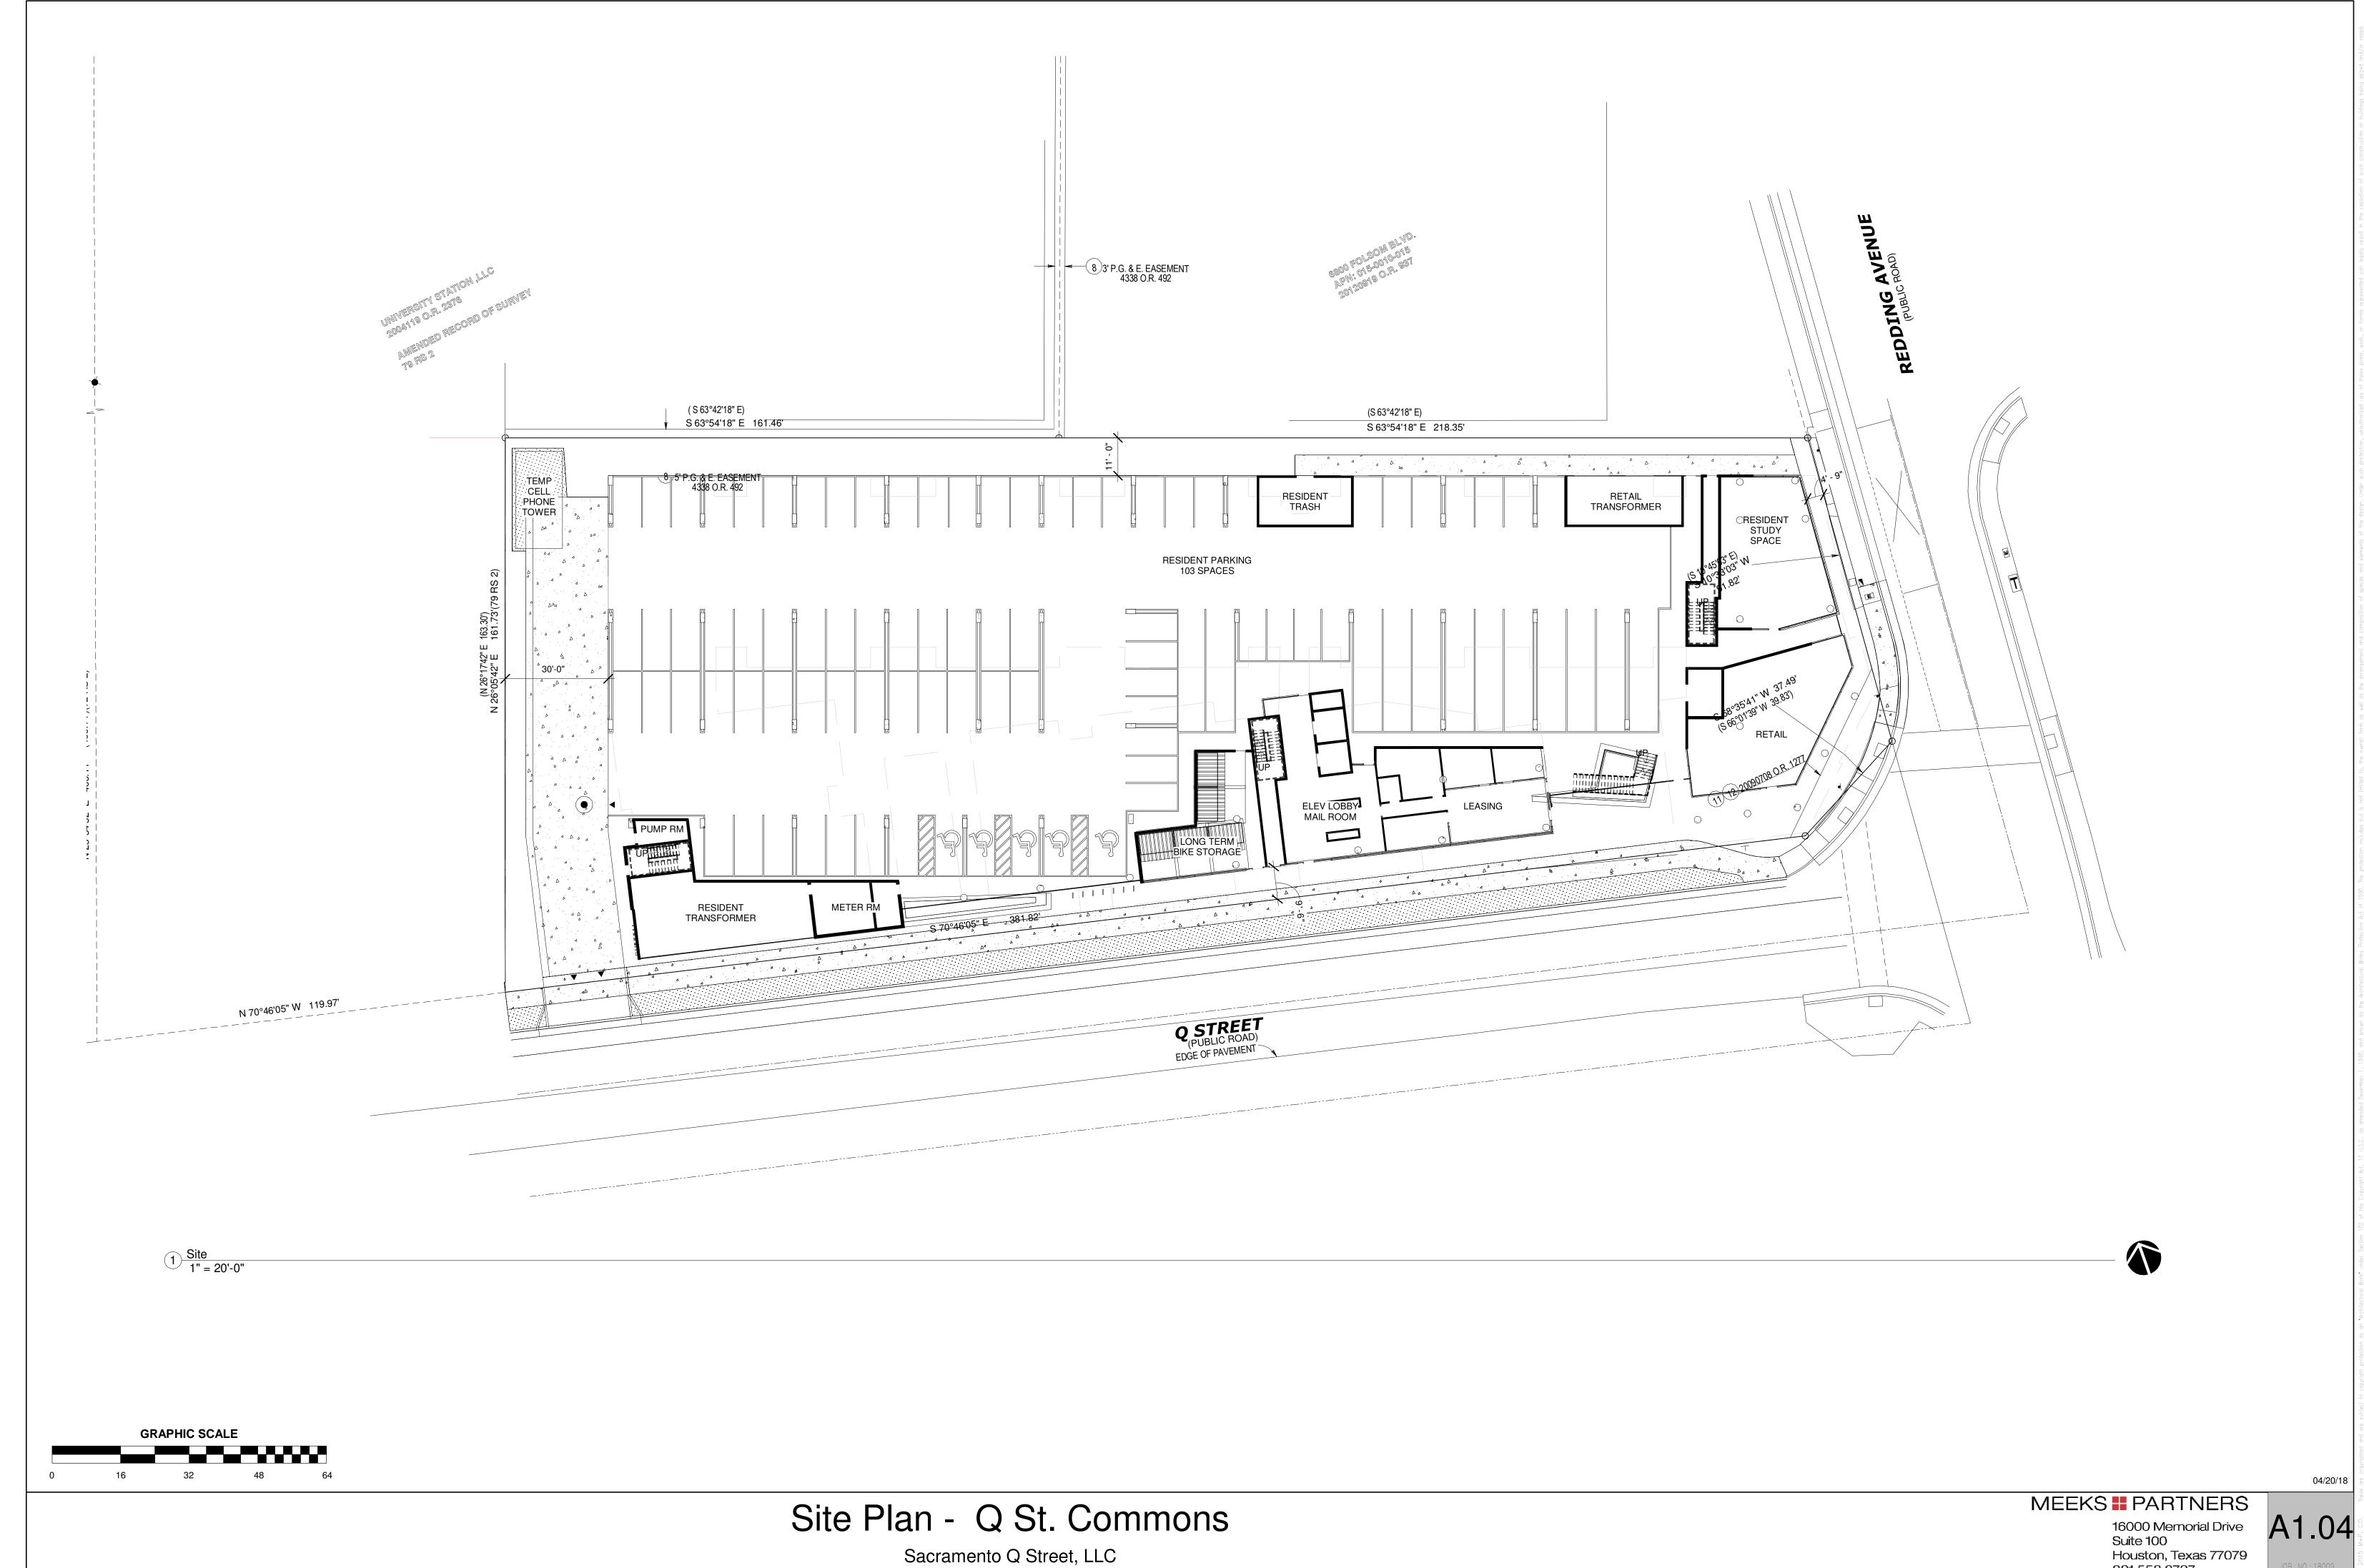



AXON LEVEL






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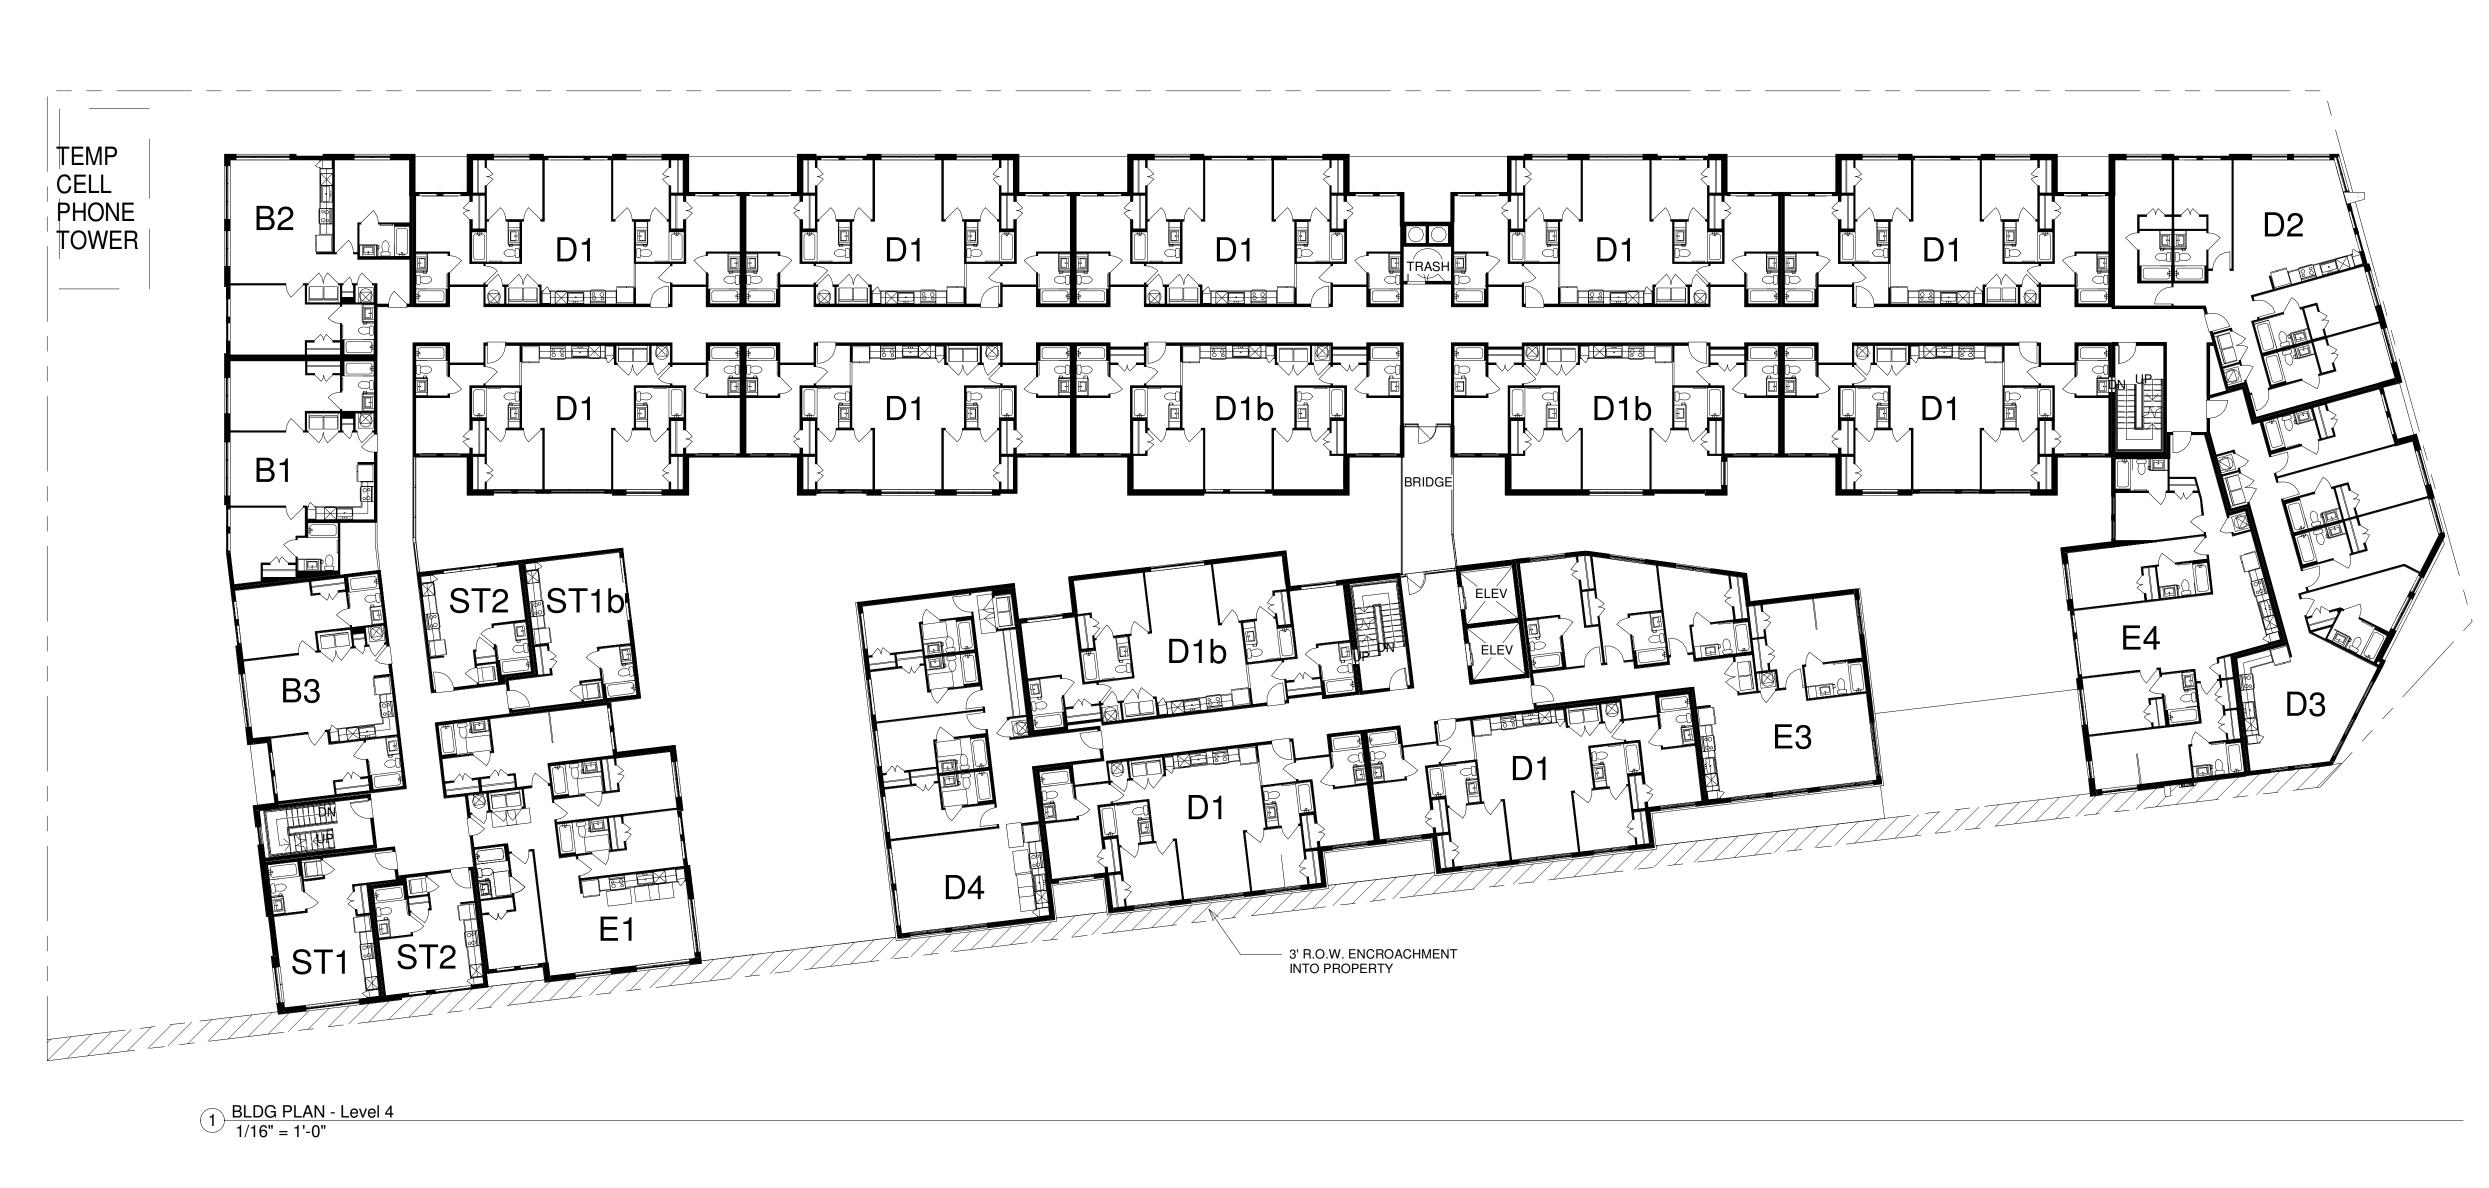


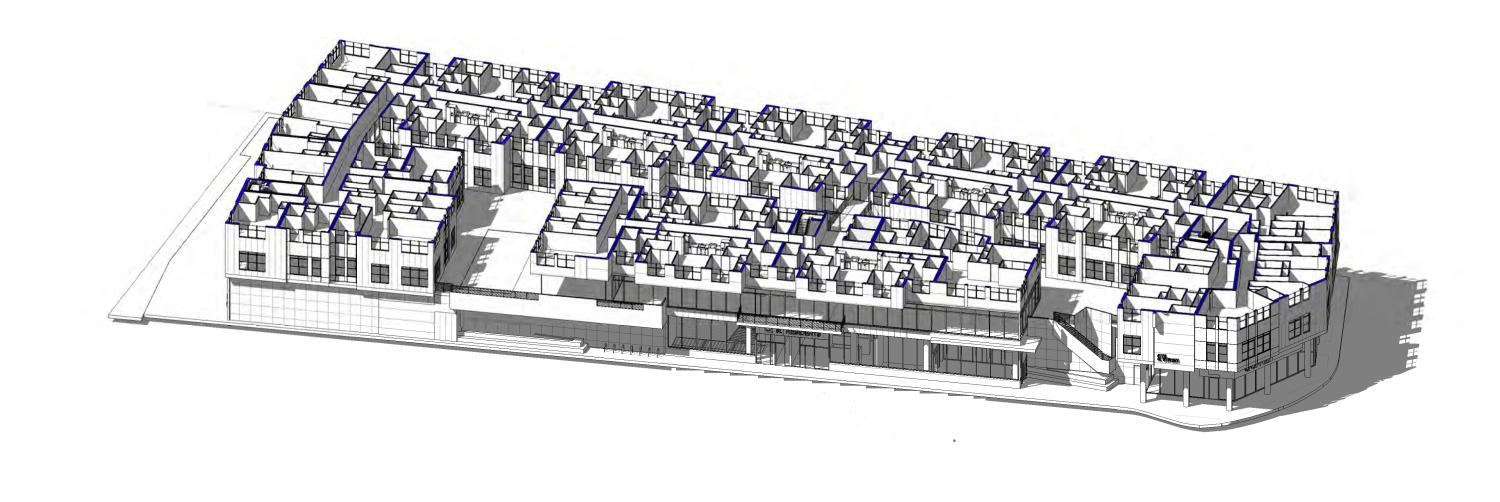


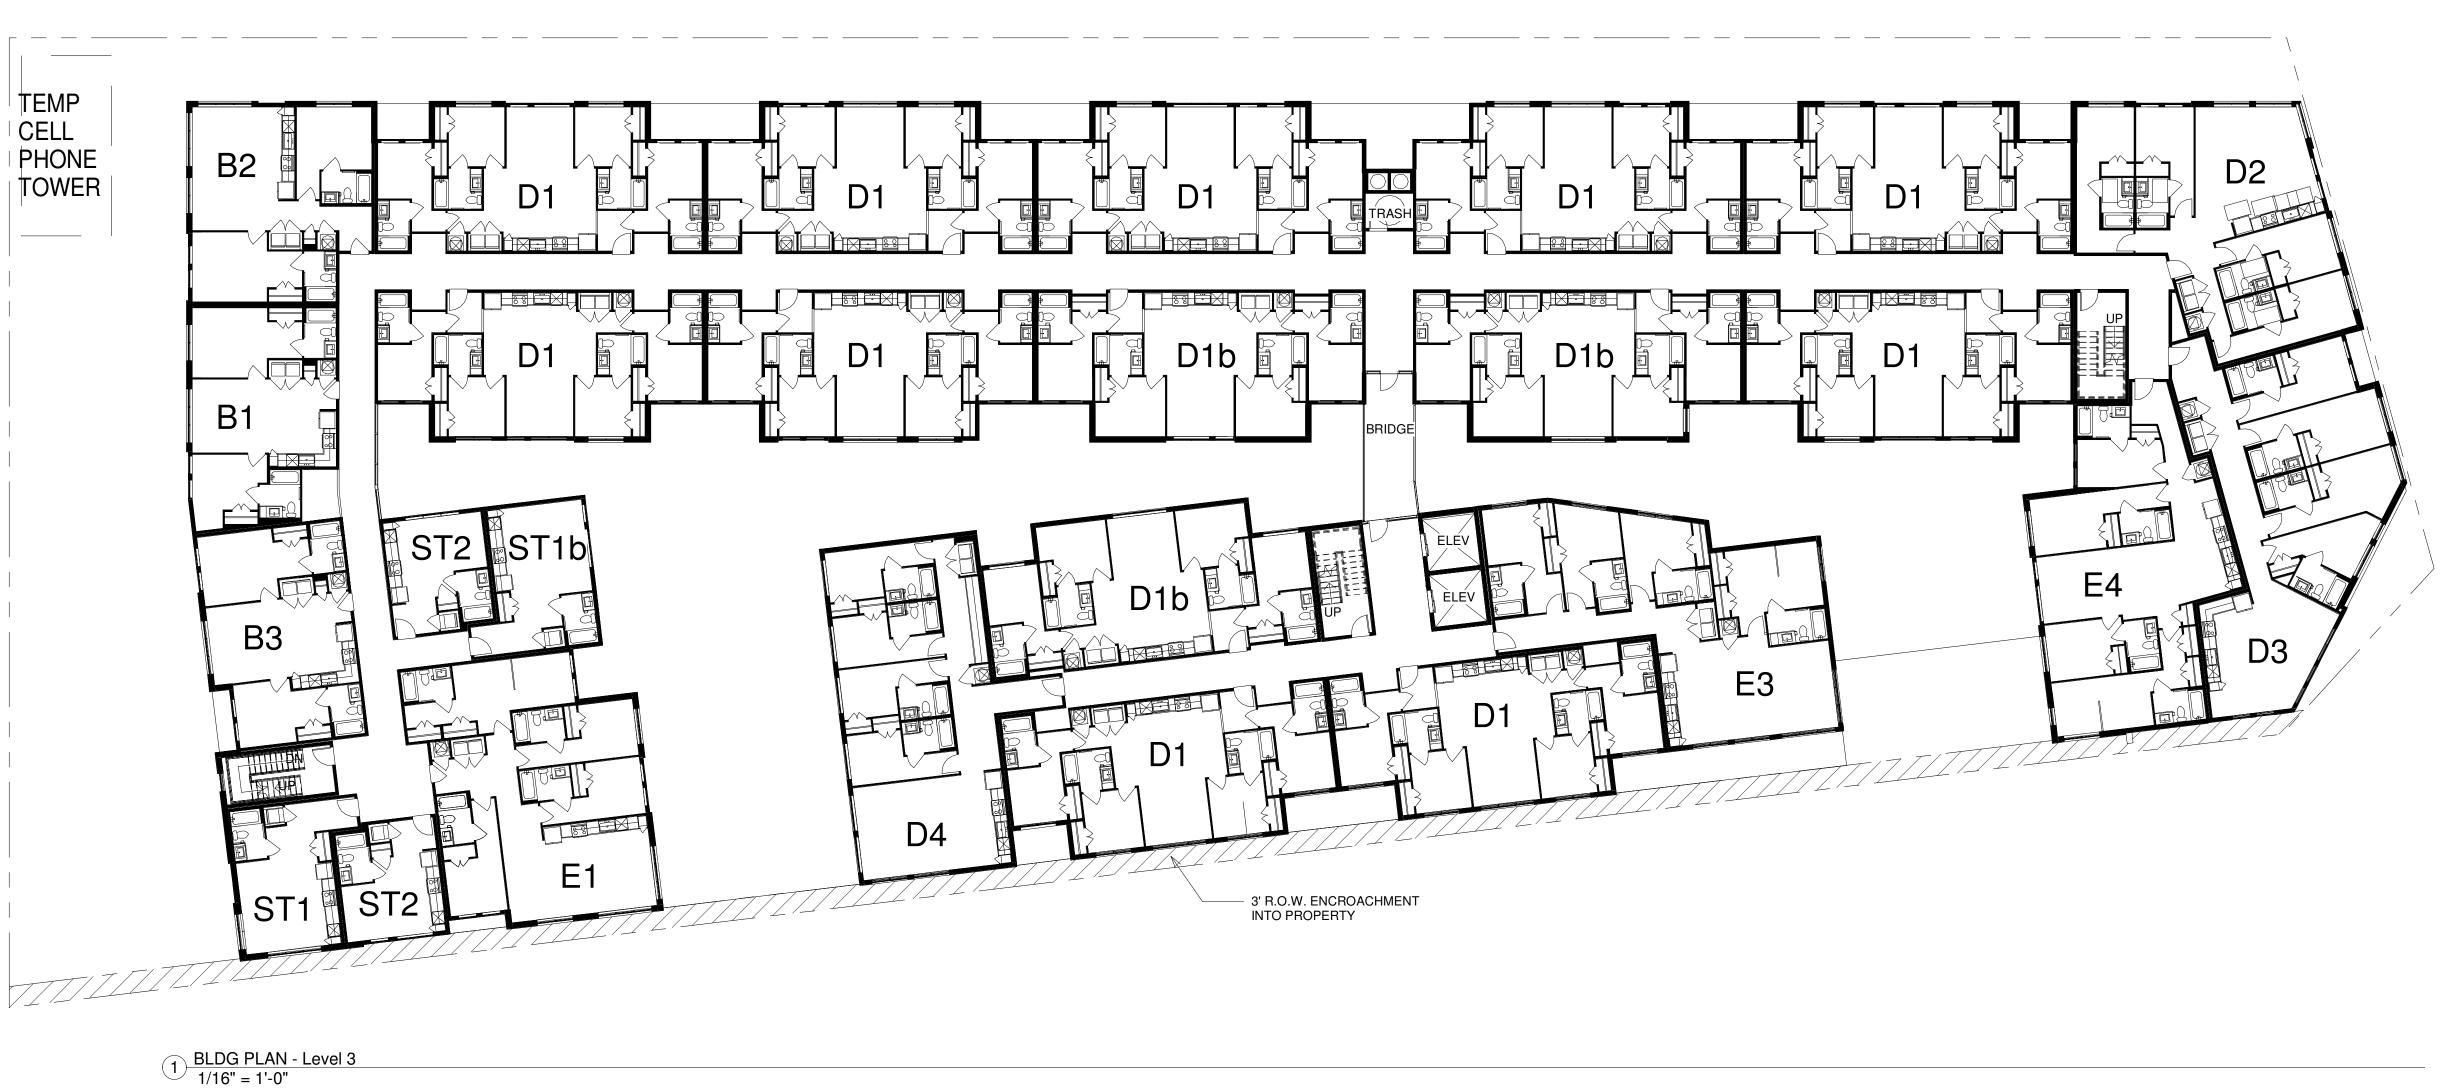

GRAPHIC SCALE



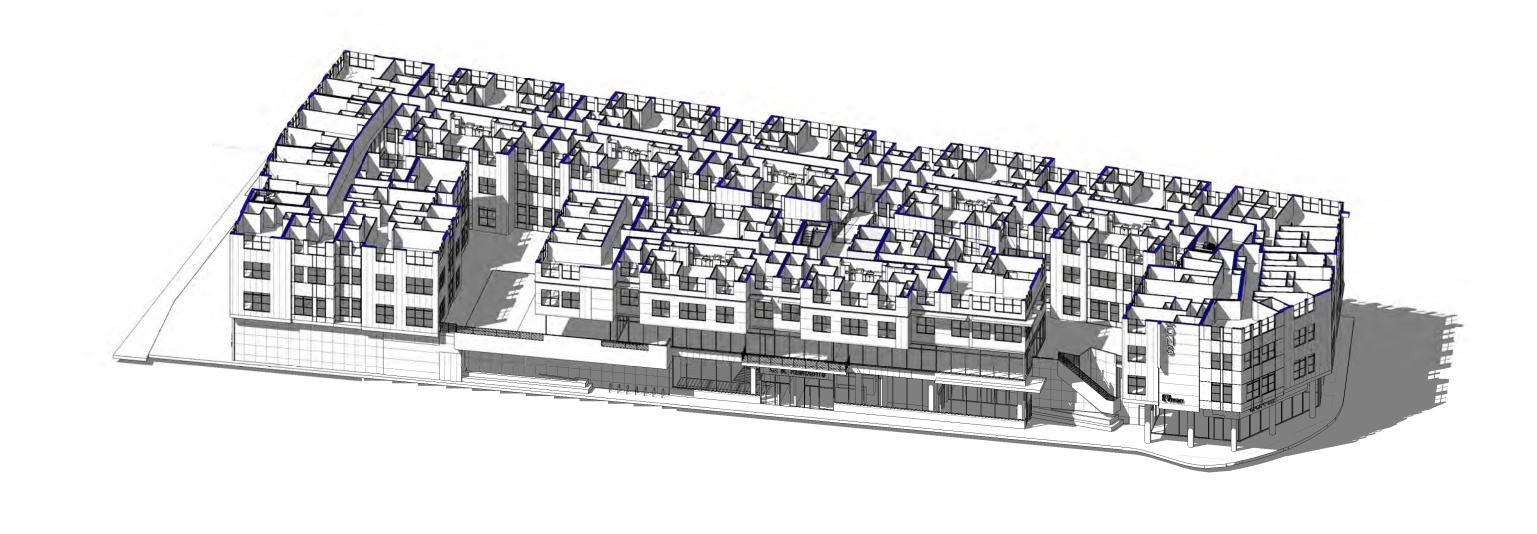

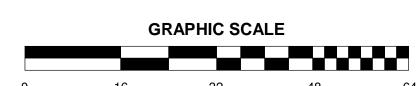




Bldg Lvl 04 - Q St. Commons







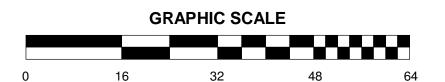

1 BLDG PLAN - Level 5 1/16" = 1'-0"




2 AXON LEVEL




GRAPHIC SCALE

1 BLDG PLAN - Level 6 1/16" = 1'-0"

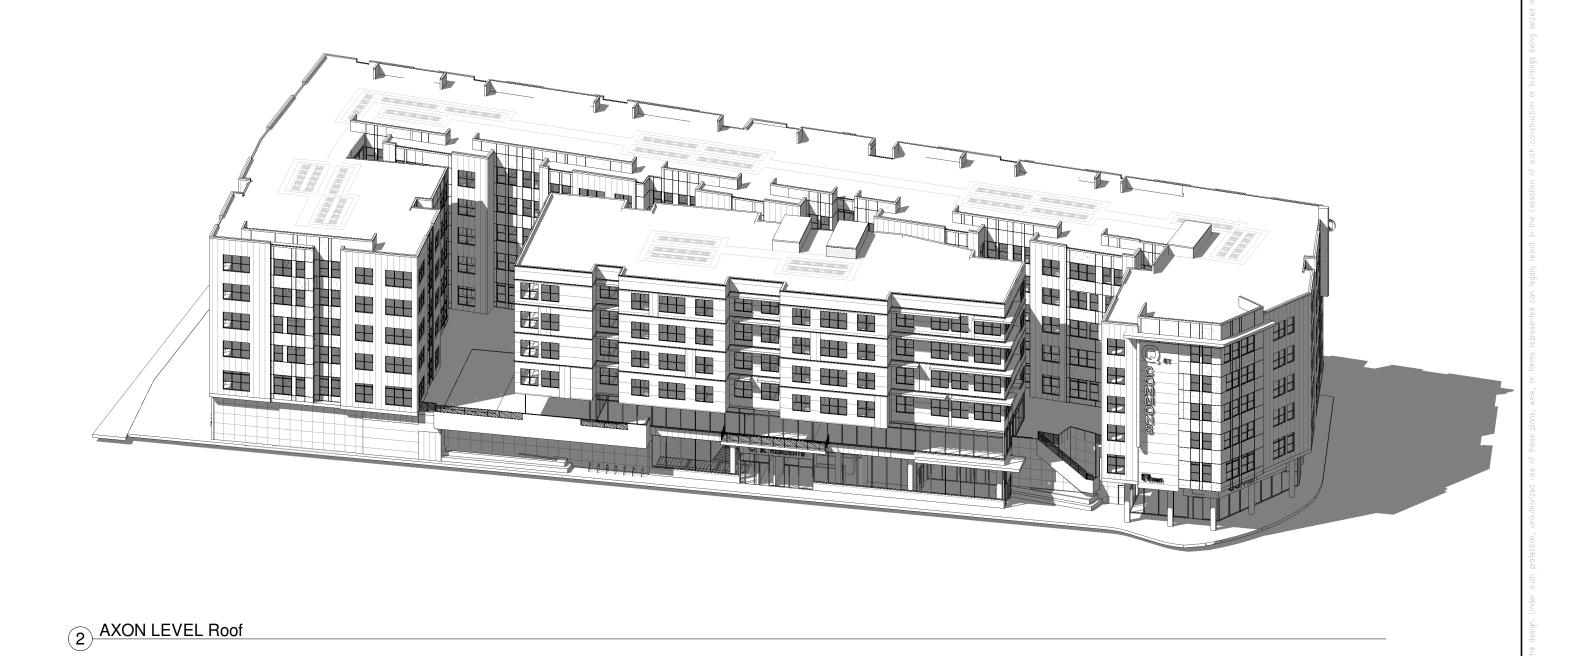


4' PARAPET WALL, TYP 8' PARAPET WALL, TYP FUTURE CELL TOWER LOCATION ROOFTOP CONDESNING UNITS ROOFTOP CONDESNING UNITS ROOFTOP CONDESNING UNITS ROOFTOP CONDESNING UNITS 8' PARAPET WALL, TYP 4' PARAPET WALL, TYP 4' PARAPET WALL, TYP 8' PARAPET WALL, TYP 4' PARAPET WALL, TYP ROOFTOP CONDESNING UNITS

1 BLDG PLAN - Level Roof 1/16" = 1'-0"

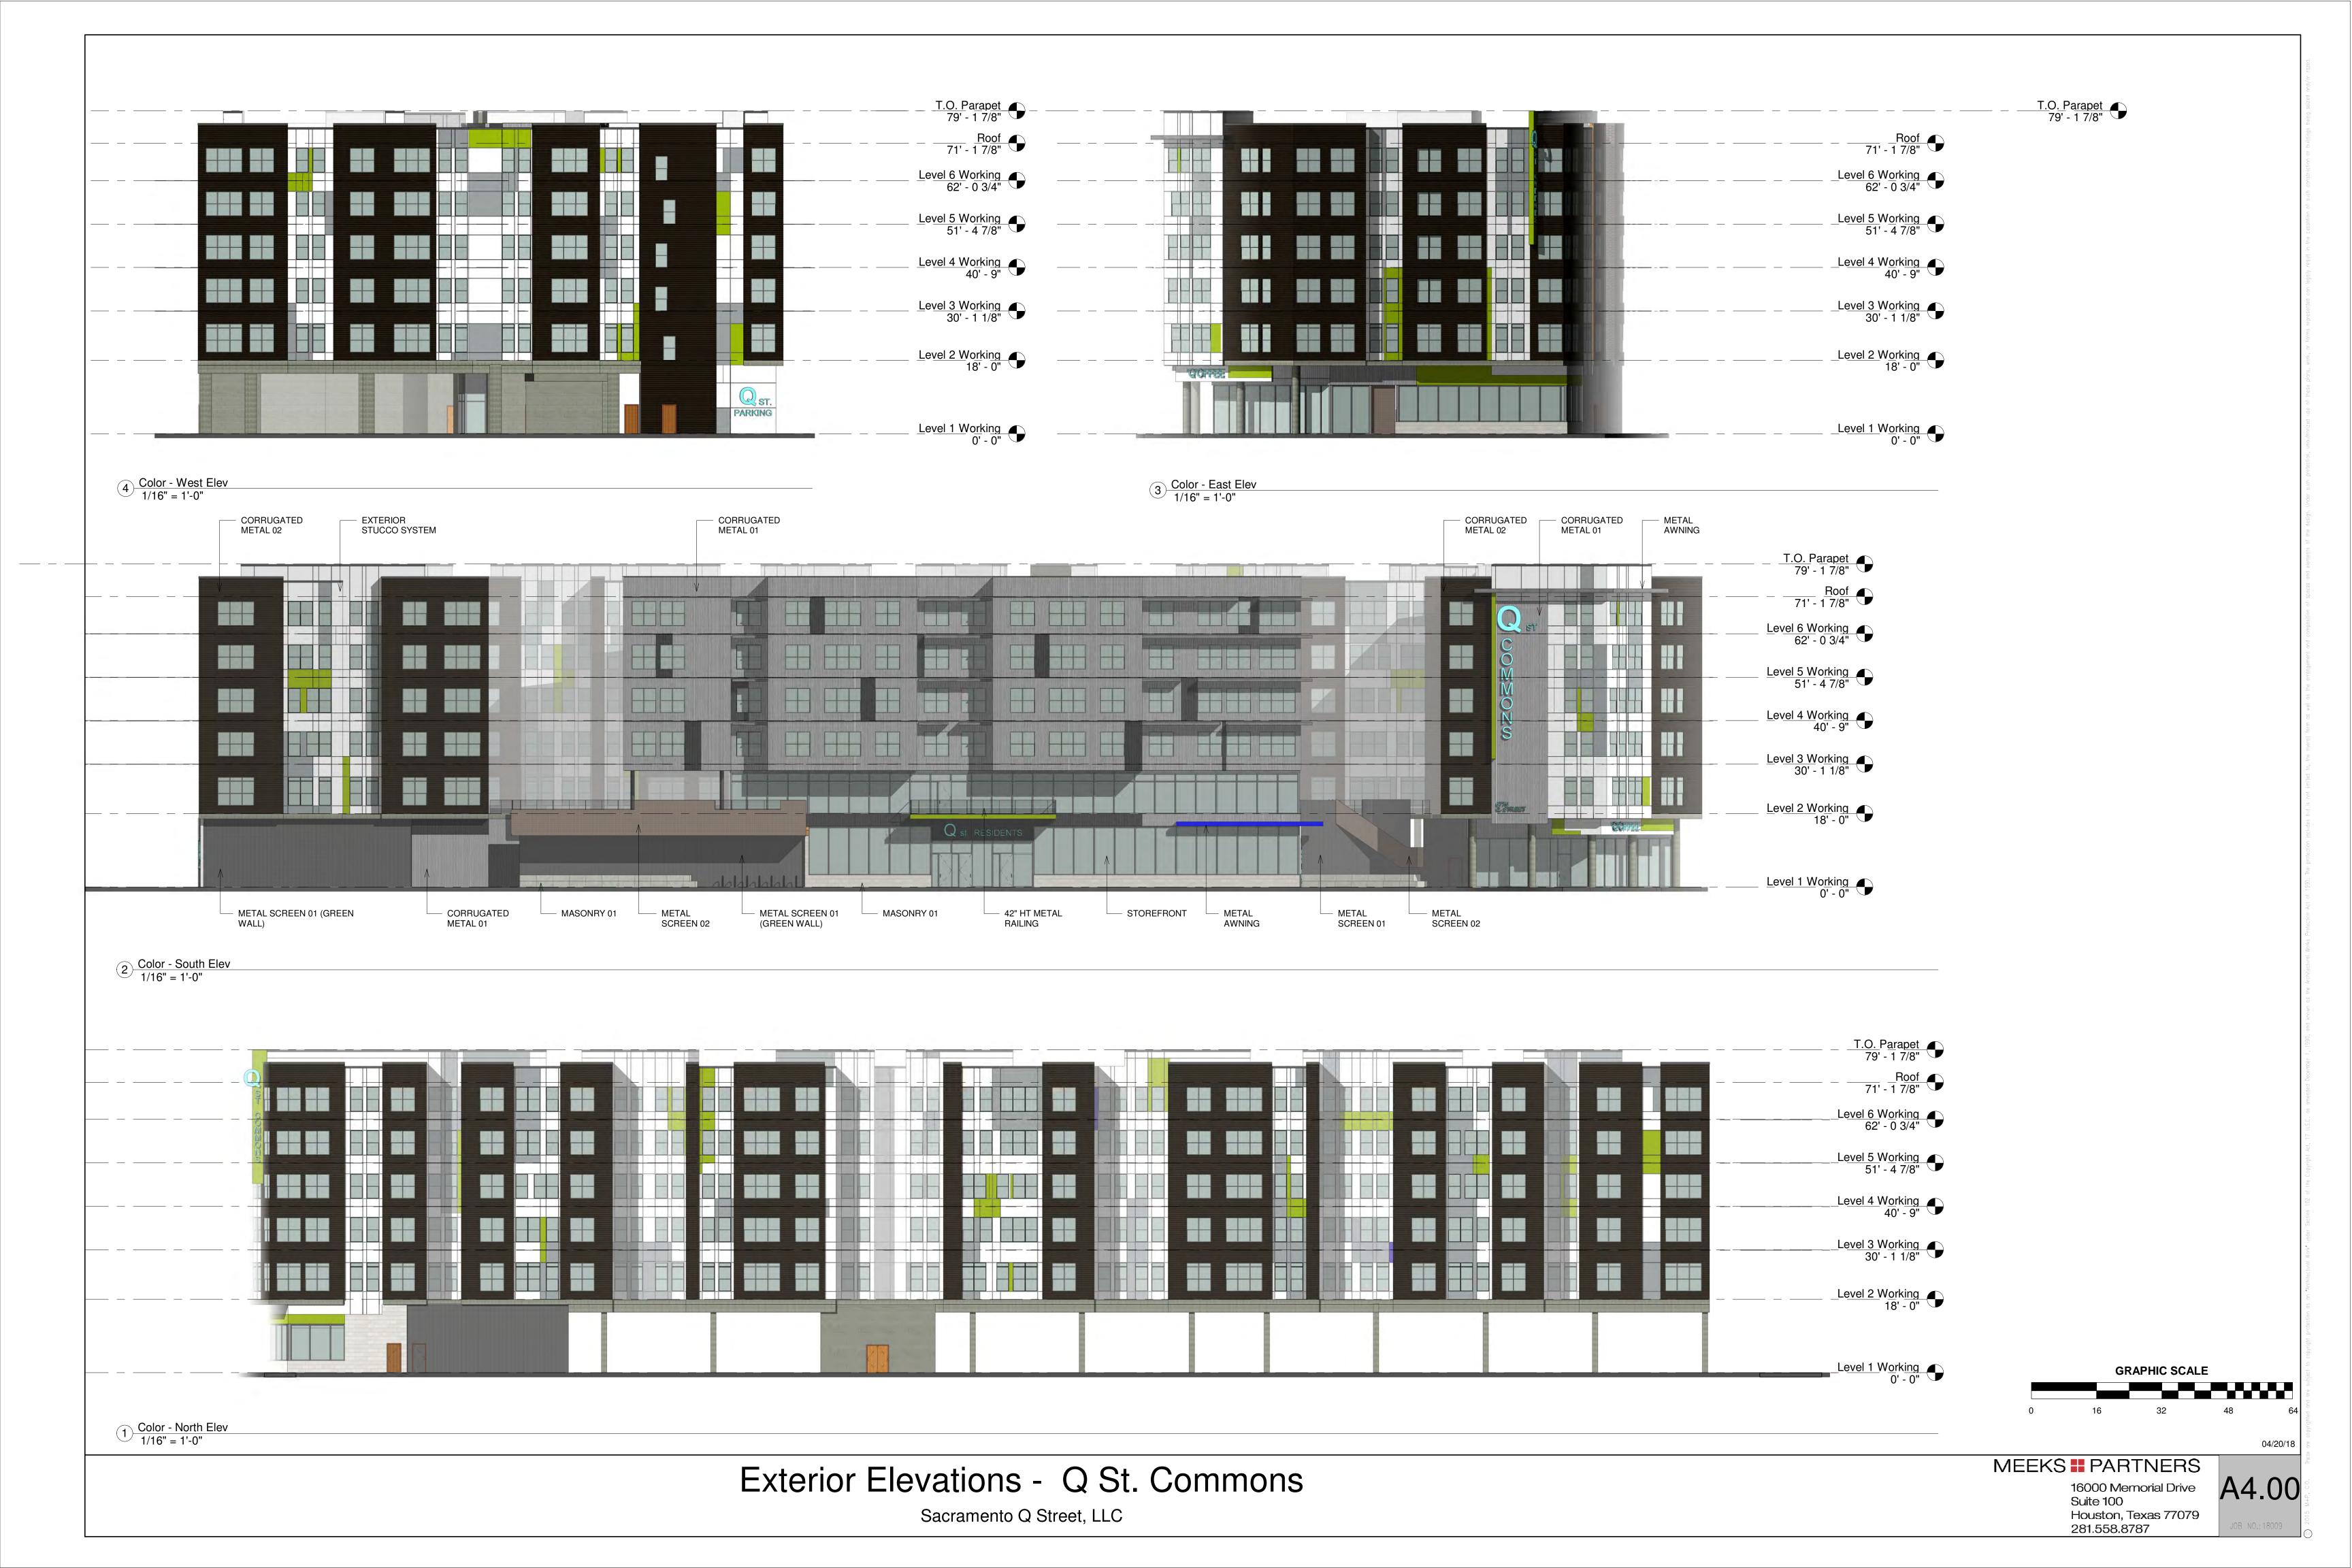




2 Section - CTYD Elev 01 1/16" = 1'-0"

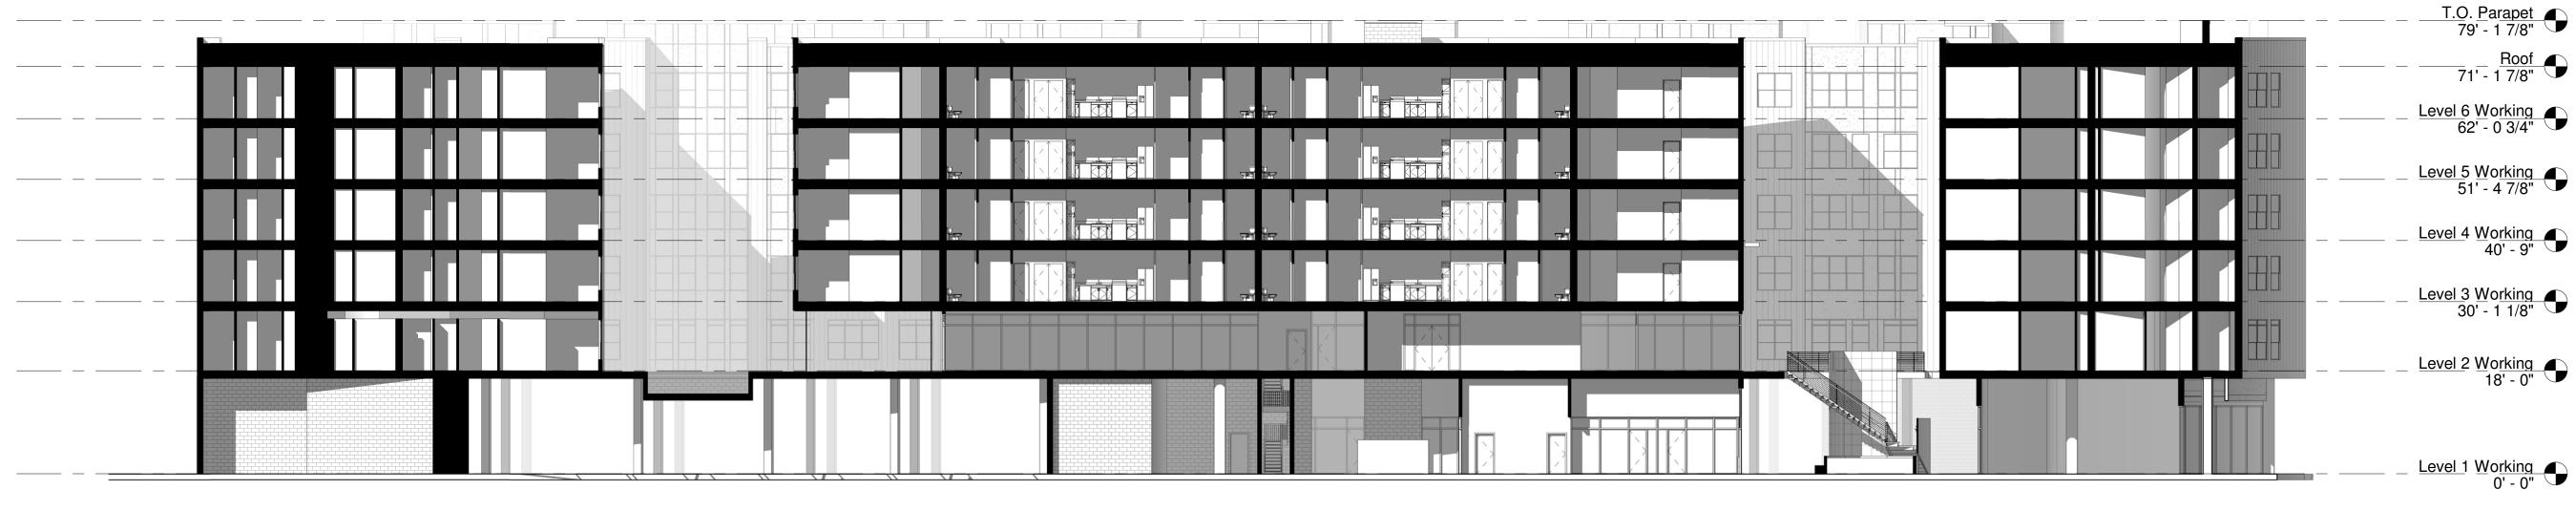

Section - Longitudnal Sect 01
1/16" = 1'-0"

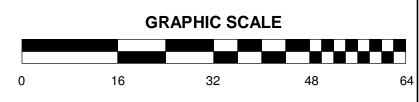



STREET VIEW LOOKING NORTHWEST AT THE CORNER OF Q ST. AND REDDING AVE



STREET VIEW LOOKING NORTH ALONG Q ST.



AERIAL VIEW LOOKING NORTH TOWARDS CAMPUS



AERIAL VIEW LOOKING SOUTH



AERIAL VIEW LOOKING NORTH TOWARDS CAMPUS

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STREET VIEW LOOKING SOUTHWEST AT THE CORNER OF 69TH ST AND REDDING AVE



STREET VIEW LOOKING SOUTH ALONG 69TH ST./REDDING AVE



STREET VIEW LOOKINIG NORTH EAST ALONG Q S



STREET VIEW LOOKING NORTHEAST ALONG Q ST.



AERIAL VIEW LOOKING NORTH TOWARDS CAMPUS



STREET VIEW LOOKING NORTHWEST AT THE CORNER OF Q ST. AND REDDING AVE



STREET VIEW LOOKING NORTH ALONG Q ST.




STREET VIEW LOOKING AT RETAIL ENTRY



AERIAL VIEW LOOKING SOUTHTH



STREET VIEW LOOKING AT LEASING ENTRY

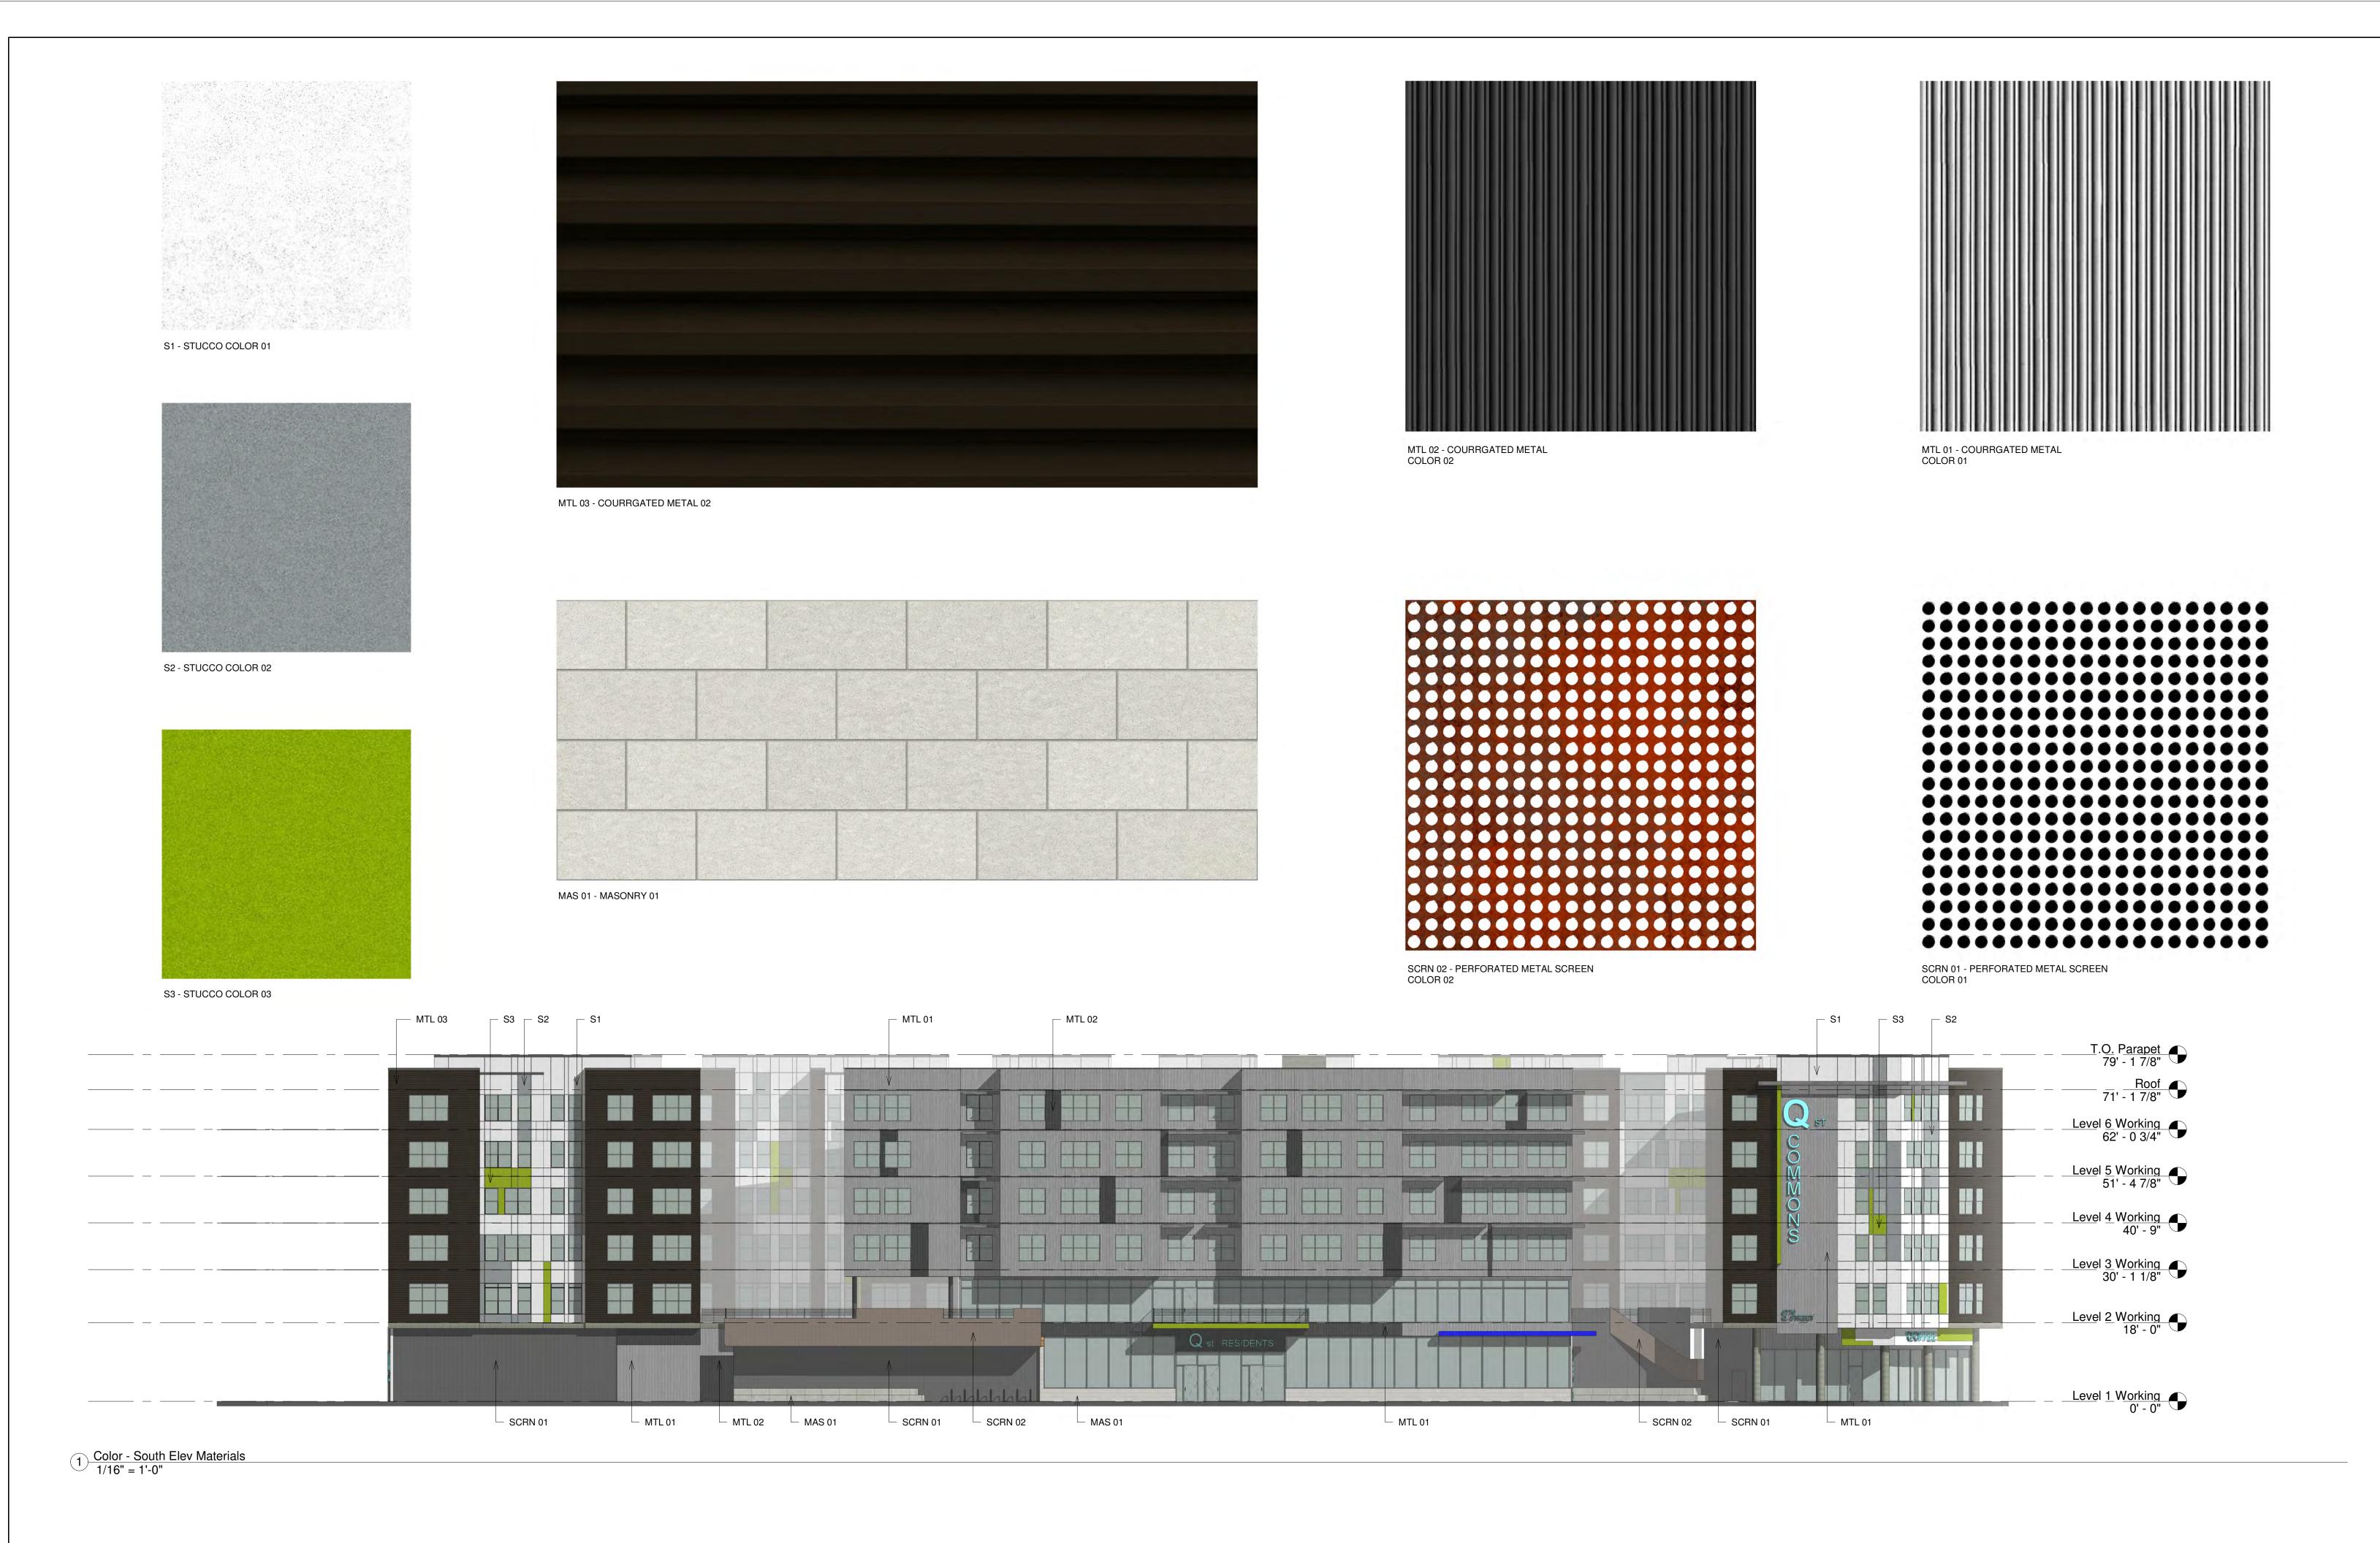

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